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A6.01

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Door & Window Schedule

# PROPOSED NEW RESIDENCE

FOR

# **SHANKLAND**



ALL LANDSCAPING, PLANTING, LIGHTING AND FENCING IS SHOWN FOR IMAGING PURPOSES ONLY. REFER TO BUILDING CONTRACT & FIXTURES AND FITTINGS FOR LANDSCAPING INCLUSIONS



ARTIST IMPRESSION ONLY

24/08/2018 BCO10269221

Auckland Council

**APPROVED** 

NOTE: Site located in sea-spray zone, all structural fixings to be type 304 stainless steel

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SHANKLAND

DRAWING TITLE: **Cover Sheet**  LEGAL DESCRIPTION: LOT: 90 DP: tbc

KAHAWAI POINT, GLENBROOK, AUCKLAND

NOTE: THE SCHEDULE OF FIXTURES AND FITTINGS TAKES PRESEDENCE OVER THESE BRAVING

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Floor Area over Foundation (incl. Covered Areas)  $192.44\ m^2\quad \hbox{(Developer Approval received for less than }200m^2\hbox{excl garage)}$ 

Site Coverage 34.79% Including Louvre System (35% Allowable)

Impervious Surface Area 260.25 m<sup>2</sup> (47.06% Including Dwelling, Garage & Louvre & Patios), Max 60%

Territorial Authority AUCKLAND COUNCIL

REISDENTIAL SINGLE HOUSE, GLENBROOK 3 PRECINCT, COASTAL ZONE Planning Zone NO

Flood Management Area Wind Zone HIGH Earthquake Zone

1kPa Snow Zone Exposure Zone Sea Spray Zone YES Coastal Hazard N/A **Technical Category** TC Zone: N/A

General: Concept subject to TA rules and regulations.

All dimensions to be confirmed on site

Concept may be subject to subdivision developer's approval

**Foundation Type** TC1 RIBRAFT (To be confirmed with Geotechnical Report)

Position of road crossing, services locations, street trees, lamp posts, parking bays, pedestrian islands etc is unknown - to be confirmed when information becomes available. Site Information:

**Boundary Information:** To be confirmed with release of Certificate of Title

Site Levels: Levels and other relevant site information for this site to be obtained

and concept updated as required prior to a contract being signed

This plan is indicative only. Landscaping to be confirmed by the client.

All Fencing to comply with the relevant Covenants.

Historical Interest: N/A **Existing Use Rights:** Flood Management Area: N/A

Required for: Street Tree relocation Developer Approval:

Front Yard setback

Minimum floor area (200m² required excl. garage)

Non Compliances Requiring RC: N/A

### Important:

Landscaping:

Timber deck areas are to be freestanding elements - not connected to main building and under 1.5m in height. Therefore these are exempt from building consent application as per the Building Act 2004, Schedule 1. Deck & steps are however are to be constructed in full accordance with NZBC D1/AS1 4.1.1, 4.1.8, 6.0 & Fig. 26 and NZBC Simple House SH/AS1 Section 3.4

### Steps & Paths:

A Step/s or appropriate landscaping is to be provided if drop from external doors is  $\frac{1}{2} \left( \frac{1}{2} \right) = \frac{1}{2} \left( \frac{1}{2} \right) \left( \frac{1}{2$ greater than 190mm from FFL to FGL. All access routes must provide a non-slip surface in accordance to NZBC D1/AS Table 2. Convey surface water from sealed drive to an appropriate approved outfall.



10/08/2018



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### NOTE: Site located in sea-spray zone, all structural fixings to be type 304 stainless steel LEGAL DESCRIPTION:

LOT: 90 DP: tbc

## NOTE: THE SCHEDULE OF FIXTURES AND FITTINGS TAKES PRECEDENCE OVER THESE DRAWINGS

24/08/2018

BCO10269221

**APPROVED BUILDING CONSENT PLANS** 

Landscaped area = 334.59

or other amenity features.

= 60.50% (min 40% required)

xcluding Driveway, Path, Service Court

The proposed landscaping will consist

predominantly of trees and/or shrub plantings.

in accordance with ther Design Guidelines, and may include ancillary areas of lawn

RFI 19/07/2018

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IGQ 19/01/2018 TECHNICIAN: AMENDMENT DATE: CM

1:200 A1.01 JOB# SA243

DAME NGANEKO DRIVE

Ecoflow water Collection
System: Approx 800mm Ø with
600mm Ø lid - Tank only
supplied by developer (Location
TBC - Landscaped surrounds.)

Boundary Height: 2,500mm, Daylight Angle: 45.00°

osed Agg: 9.15 m

Driveway

Concrete: 27.00 r

Ecoflow Control Panel to be mounted down low, painted to

match cladding.
Confirm location with Site levels

DRAWING TITLE:

Site Plan

KAHAWAI POINT, GLENBROOK, AUCKLAND

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OPEN SPACE - INFORMAL RECREATION TO NOT THE PROPERTY OF THE PR

**Detached Deck** 

Outdoor Living: 40.00 m2 max 1:20 gradient

DB

+13,800

Service Court

Patio

Exposed Agg: 23.76 m<sup>2</sup>

MBCOMM

3,000

PROPOSED DWELLING

FPL +13,650

23/03/2018

VERSION: CODE:

Auckland |





Main contractor to provide 2m min. high chain link fence (min. size 50 x 50mm) to prevent unauthorised entry to the site. All fencing to comply with F5 including relevant hazard signage.

Main contractor to provide on site a specific Health & Safety policy which is to be viewed & signed by all persons entering the site.


### **Sediment Control:**

- Rumble pad to be created at point of entry & exit on site (Removed on completion of formed driveway) Rumble pad to be created in accordance to guidelines provided by the local Council & maintained in good condition throughout it's period of use.
- All ground cover/vegetation outside of immediate build area to be maintained throughout period of house build. This includes grass verges on the street frontage.
- Any stockpiles of soil or excavated material are to be kept to the rear of the site & covered with imprevious sheets. - Roof downpipes are to be connected to the installed stormwater drainage as soon as practical once roof cladding has been installed. Until this point ensure water run-off from downpipes is directed away from build area but not on to
- No building work will be started on this project until the construction of an approved stormwater outfall has been completed for this proposed lot.

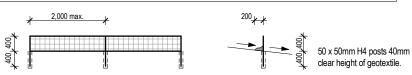

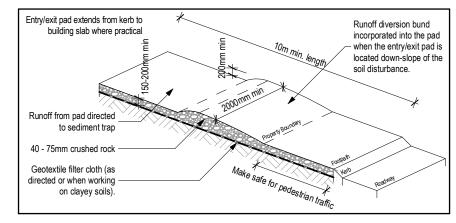

## Stabilised Entry Pad

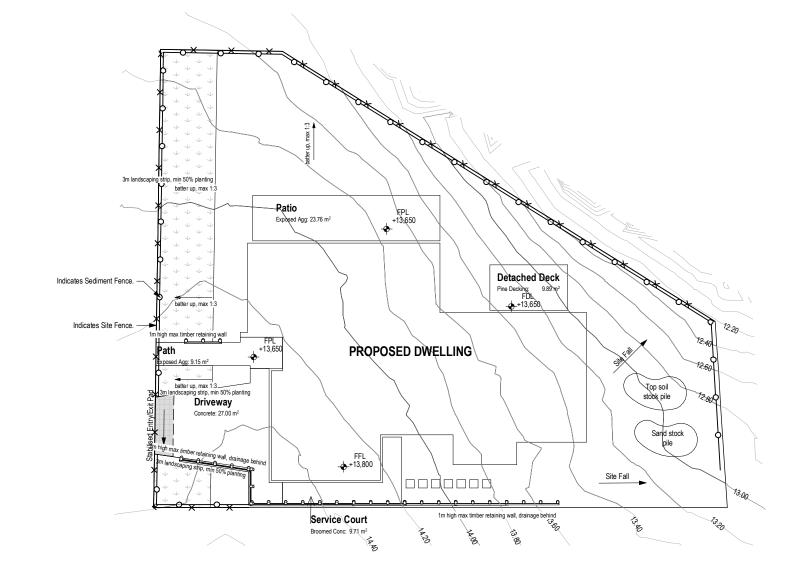

Auckland 24/08/2018 BCO10269221 **APPROVED** 

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**Sediment Control Plan** 

LEGAL DESCRIPTION LOT: 90 DP: tbc

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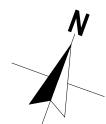
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**SHANKLAND** 



137.07m<sup>3</sup>

### **CUT AND FILL NOTES**


137.07m<sup>3</sup> Cut Volume Fill Volume

**CUT AND FILL LEGEND** 



Total Volume



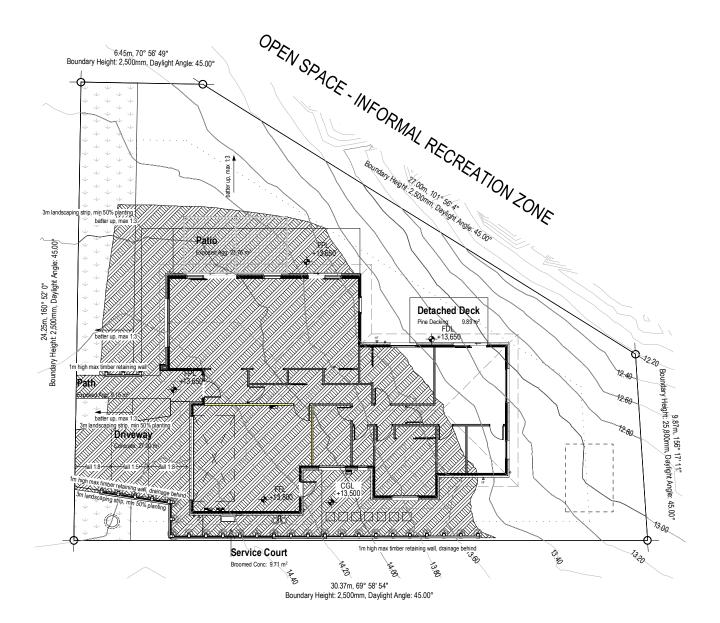

## Earthworks Plan

SCALE 1:200 @A3

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DRAWING TITLE:

LEGAL DESCRIPTION LOT: 90 DP: tbc

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**Earthworks Plan** 

KAHAWAI POINT, GLENBROOK, AUCKLAND

- WC riser locations have a typical offset of 140mm from internal line of framing to center of waste. (Manufacturers technical specifications should be consulted to confirm offset)

-Vanity & Tub riser locations have a typical offset of 45mm to centre line of wall framing to centre of waste.

- Mesh in floor slab must be earthed. Earth with 16mm REO rod brought up into garage wall below meterox & wired to the mesh. At prewire, connect a clamp & piece of wire to rod & earth it to the meterbox.

- Minimum heights of concrete slab on ground above surrounding ground levels to be 150mm to sealed surface & 225mm to unsealed ground as per NZBC E2

Finished floor level to be 150mm minimum above crown of road as per NZBC E1/AS1.

- Confirm layout of fittings of kitchen & bathroom etc. before foundation commences.

### **RIBRAFT NOTES:**

-Ribraft floor to be installed in accordance with Firth Ribraft Technical Manual 2012 28MPa Raftmix concrete

-SE62 mesh


-85mm thick slab

-1100x1100x220mm thick polystyrene pods

-Building platform to extend 1m beyond slab edge

-Ultimate bearing capacity determined by scala penetrometer testing shall exceed 7 blows per 300mm of depth, or the site complies with NZS3604:2011

In order to limit cracking at the re-entrant, or internal corners, extra steel shall be placed on top of the mesh. These shall be 2-HD12 bars (Grade 500E), 1200mm long tied to the top of the mesh at 200mm centres, with 50mm cover from the internal corner

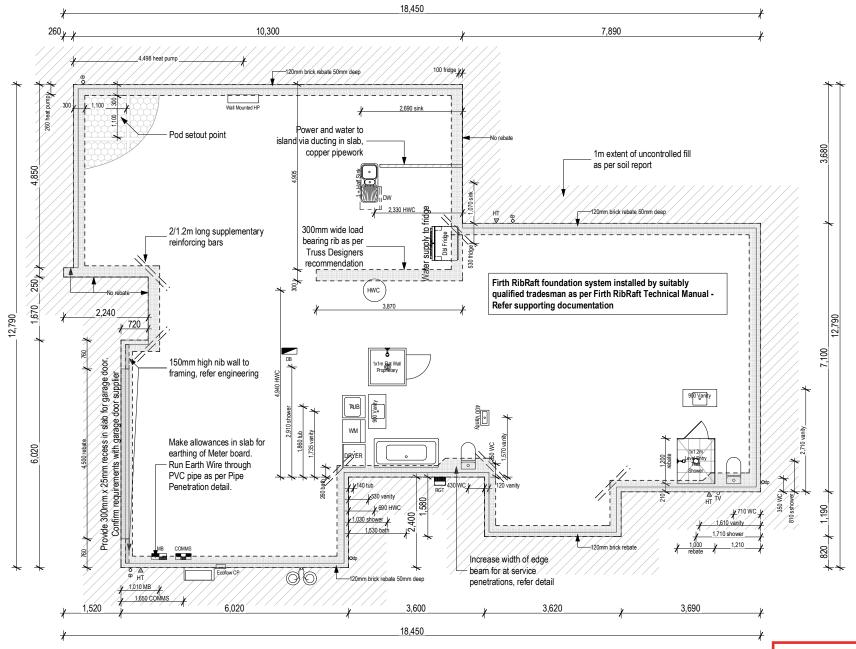

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SCALE: A1.04

**SHANKLAND** 

**Foundation Plan** 

AUCKLAND

LEGAL DESCRIPTION

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1:100 JOB# VERSION: CODE: SA243



### **LEGEND**

Ref	Fixture	Waste Size	Gradien
WC	Water Closet	100mm	1:60
В	Bath	65mm	1:40
SH	Shower	65mm	1:40
S	Kitchen Sink + DW	65mm	1:40
Van.U	Vanity Unit	65mm	1:40
WHB	Wash Hand Basin	65mm	1:40
TUB	Laundry Tub + WM	65mm	1:40
HWC	Hot Water Cylinder	20mm	1:40
WM	Washing Machine	Discharge to TUB	
GT	Gully Trap	-	
RGT	Relief Gully Trap		
TV	Terminal Vent	50mm	
BV	Branch Vent	40mm	
DP	Downpipe	80mm dia	
RP	Rodding Point		
IP	Inspection Point		
AAV	Air Admittance Valve		
HT	Hose Tap		
HP√	Weat Pump		$\langle \rangle$
		•	•
	100mm u	PVC surface water drain a	at 1:100 gradier
	existing la	aterals at boundary. (SW)	-

100mm uPVC surface water drain at 1:100 gradient to detention pit. (SW)

100mm dPVC foul water drain at 1:60 gradient to existing laterals at boundary. (FW)

110mm Novaflo Drainage behind Retaining Wall with silt trap. (Retaining wall detail refer to engineer design)

### Note:

- Relief Gully Trap is to be positioned so that the top of the gully dish is no less than 150mm below the overflow level of the lowest sanitary fixture served by the drainage system.
- Position of drain connections at street laterals to be confirmed on site.
- Allow to thermally insulate all exterior pipework & valves exposed to external weather conditions.


### **General Note:**

All plumbing and drainage to comply with Acceptable Solutions AS/NZS 3500 by qualifed tradesman. Allow to check all dimensions and falls of drains onsite prior to installation. Use 80mm dia downpipes. Contractor to locate all service connections on site prior to earthworks, confirm all boundary setbacks & restrictions comply with current regulations prior to commencement of foundations.

All waste pipes PVC. Sizes, fall, venting & discharge to be confirmed by NZ qualifed plumber. Confirm positions of available services cabling etc. on site prior to any excavation. Internal water pipes to be Polybutylene. All pipework & pipes exposed to freezing to be lagged with closed cell foam.

### **RIBRAFT NOTE:**

Services shall not be placed within any concrete except to cross that section of concrete, i.e. services shall not run along ribs or edge beams. Refer details

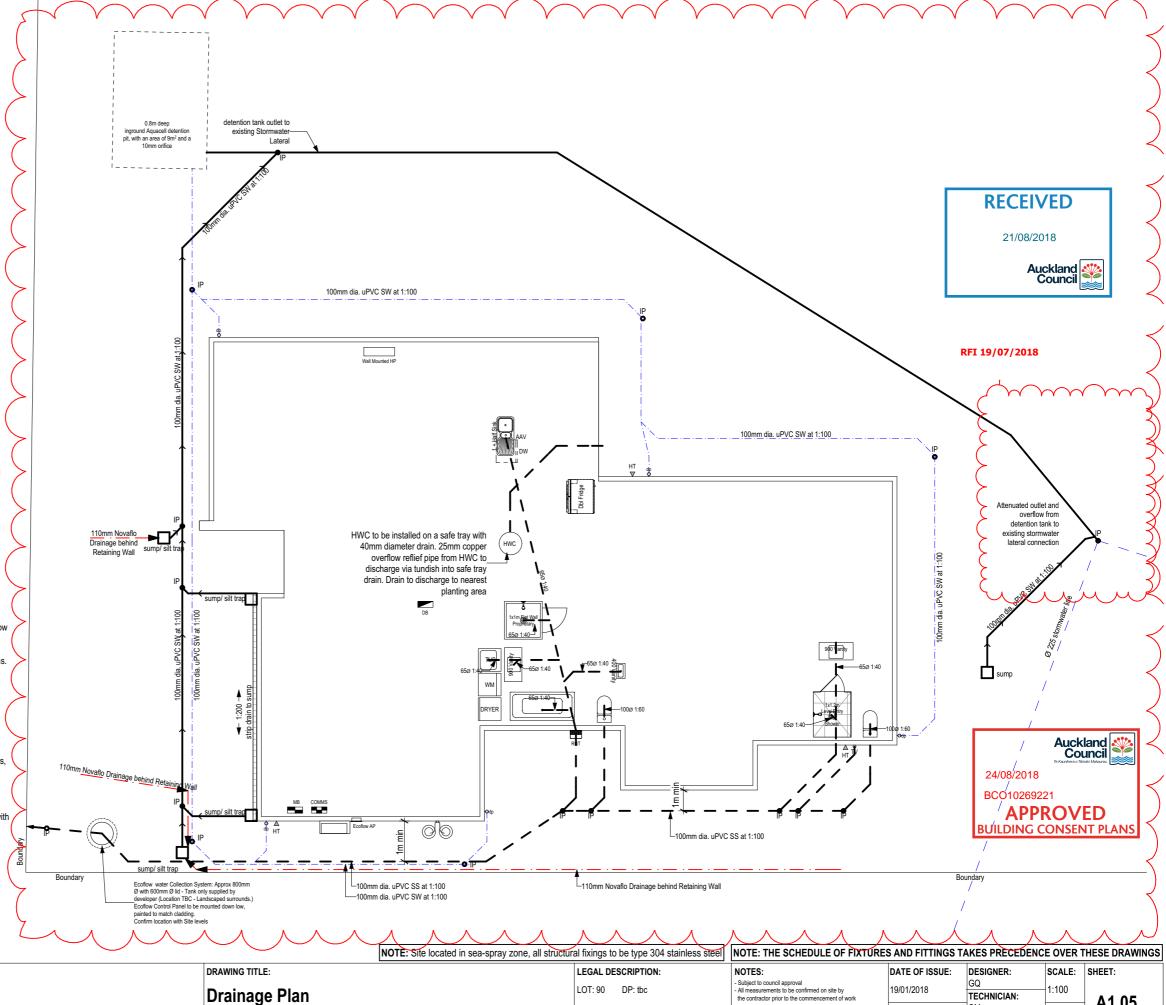

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AMENDMENT DATE: CM

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SHANKLAND



### **GENERAL NOTES**

Roofing Materials

166.76 m<sup>2</sup> Floor Area over Framing 173.76 m<sup>2</sup> Floor Area over Foundation 192.44 m<sup>2</sup> Floor Area over Foundation (incl. Covered Areas)

Maximum Building Height 8m Perimeter (Over Foundation) 67,080.mm

Wall Cladding Materials 70 series Brick Veneer on 50mm cavity

James Hardie Linea Weatherboard on 20mm cavity, 150mm, corner

soakers

Colorsteel Maxx Longrun 5 Rib

TRADITIONAL Construction Method Pod Bathroom USG

35mm Metal ceiling battens @ 400mm crs Ceiling Battens

20° Roof Pitch Eaves Width 600mm Height To Underside Of Truss 2755mm Lintel Height 2184mm Soffit Height 2499mm

Note: in High Wind Zone 2755mm stud height: 90x45mm studs @ 400mm centres 2755mm stud height: 140x45mm studs @ 600mm centres

Internal Door Leaf Height Overheight - 2.2m Internal Door Leaf Width Typically 810mm

Typically 710mm (Wet Areas)

2x 9kg bottles Gas Supply

General All dimensions to be confirmed on site

Heating: Heat pump to be fixed in position shown on the drawings.

Refer to specifications for more information.

Ceiling Vents: Bathroom & Ensuite to vent directly to exterior

Laundry to vent directly to exterior (unless opening window)

Range Hood to exit through soffit lining.

Required within 3m of all sleeping areas, change in level & entry/exits as per NZS 4514 & BRANZ Bulletins No's 252 & 309 Smoke Alarms:

FXTRAS:

ENGINEERING: Architraves to doors & windows throughout Foundation Natural palette of colours Retaining walls Garage door to be a recessive colour

Alarm System Outdoor Lighting max 150 Lux Native Planting to be locally sourced 3x attic trusses, attic ladder

Cat Door

FLOOR PLAN NOTES:

- All glazing to comply with NZS4223

- All hard floor finishes to comply with NZBC D1/AS Table 2. Floor tiles to be non-slip & have a slip coefficient value of 0.35 - 0.65 for grit finished ceramic tiles.

- Hot water pipes to be sized according to NZBC G12 & NZS4305:1996. Mains pressure: 15mm dia. allows 12mm max. pipe length. Pipe length beyond this must be lagged.

- Satin enamel wall finish to bathroom, ensuite & those walls adjacent to sinks etc. in kitchen & laundry. One row of tiles to be used above basins, vanities & benches. Bottom edge to be filled with fungus/mold resistant sealant.

### WATER PROOFING MEMBRANE NOTE:

Ardex Superflex waterproofing membrane required to tiled bathrooms with tiled rebated/level access showers.

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# LEGAL DESCRIPTION

LOT: 90 DP: tbc KAHAWAI POINT, GLENBROOK, AUCKLAND

## NOTES: Subject to council approval All measurements to be confirmed on site by the contractor prior to the commencement of work

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**APPROVED** 

Auckland

,600 ×2,184 LIVING / DINING / KITCHEN 10.00 x 4.75 BEDROOM 2 STUDY NOOK LINEN HWC 3.20 x 3.00 BEDRÓOM 1 4.09 x 3.70 27 x 1.79 HALL HALL ROBE BATH 3.20 x 2.00 Tiles: 3.70 m<sup>2</sup> ENSUITE 2.50 x 1.51 2.50 \$ 2.00 GARAGE BEDROOM 3 3.20 x 3.00

## **Ground Floor Plan**

SCALE 1:100 @A3

NOTE: Site located in sea-spray zone, all structural fixings to be type 304 stainless steel

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**SHANKLAND** 

**Ground Floor Plan** 

R3.2 Ceiling (excluding garage)

Typical stud height: 2755mm to underside of truss. 90x45mm SG8

@ 400mm crs max. 140x45mm SG8 @ 600mm crs

max, in HIGH wind zone.

Window lintel height: 2184mm Overheight 2.2m Internal door leaf height

Typically 810mm Internal door leaf width

Typically 710mm (Wet areas)

All exterior window & door lintels by truss General:

manufacturer, Internal nonloadbearing walls to be SG8 graded. All dimensions to be confirmed on site

### **FIXING SCHEDULE:**

JOINT: FIXING:

Exterior Bottom plate to concrete floor (Non-braced): Anchors shall be M12 bolts set within

150mm of each end plate, spaced at a maximum of 900mm crs. bent to prevent turning and projecting sufficiently to allow a washer and fully threaded nut above the timber. Refer to NZS3604: 2011 Refer to bracing plan for additional

Interior bottom plate to concrete floor

hold down fixings.
75 x 8mm shot fired fastenings with 16mm washers @ 600mm crs, within

> 150mm each end of plate Refer to bracing plan for additional

100 x 3.75mm nails @ 600mm crs

Refer to truss design (Or 2/90mm x 3.15mm skew nails plus 2/wiredogs.

2/100 x 3.75mm nails

hold down fixings. 4/100 x 3.15mm skewed nails Stud to Bottom or Top plate: 2/100 x 3.15mm skewed nails Dwang to stud: Fish plate to Straightened stud: 4/60 x 2 8mm nails each side 4/100 x 3.15mm skewed nails Half Joint in top Plate: 4/100 x 3.15mm skewed nails Lintel to trimming Stud:

2/100 x 3.75mm nails

Standard soffit stringer to stud: Sill trimmer to trimming stud for: - Trimmer not exceeding 2400mm 2/100 x 3.75mm end nails - Trimmer not exceeding 3000mm 3/100 x 3.75mm end nails - Trmmer not exceeding 3600mm 4/100x3.75mm end nails Double top plate to top plate: 2/100 x 3.75mm @ 500mm crs

Trimming studs together at openings, Studs & blocking at wall intersections:

Trimming Stud to Doubling Stud immediately

under lintels:

Trusses to Top Plate:

(Alt. fixing 4.7Kn) Ceiling battens to Truss bottom chord:

2/75 x 3.15mm nails @ 400mm crs Outrigger to Gable Top Plate: 1/14g self drilling screw, 150mm long 2/100 x 3.75mm end nails Outrigger to Truss: Flying Rafter to Outrigger: 2/100 x 3.75mm end nails Outrigger Blocking to Top Plate: 4/100 x 3.75mm skewed nails 1/10g self drilling screw, 80mm long

SCHEDULE OF FRAMING TIMBERS - GRADING AND TREATMENT

Wall framing

SG8, H1.2, Pinus radiata Exterior walls & lintels SG8, H1.2, Pinus radiata Interior walls (loadbearing) SG8, H1.2, Pinus radiata Interior walls (non-loadbearing) Wet Area Bottom plates & Framing SG8, H3.2, Pinus radiata

Cavity battens


SG8, H3.2, Pinus radiata -Dry Cavity -Wet Cavity SG8, H3.2, Pinus radiata

Roof framing

SG8, H1.2, Pinus radiata Roof trusses - typical SG8, H1.2, Pinus radiata Gable end truss SG8. H1.2. Pinus radiata Coved or attic trusses SG8, H1.2, Pinus radiata Purlins/Battens SG8, H1.2, Pinus radiata Valley boards, barge boards

Windows

Dressed, H3.1, Pinus radiata Framing and reveals

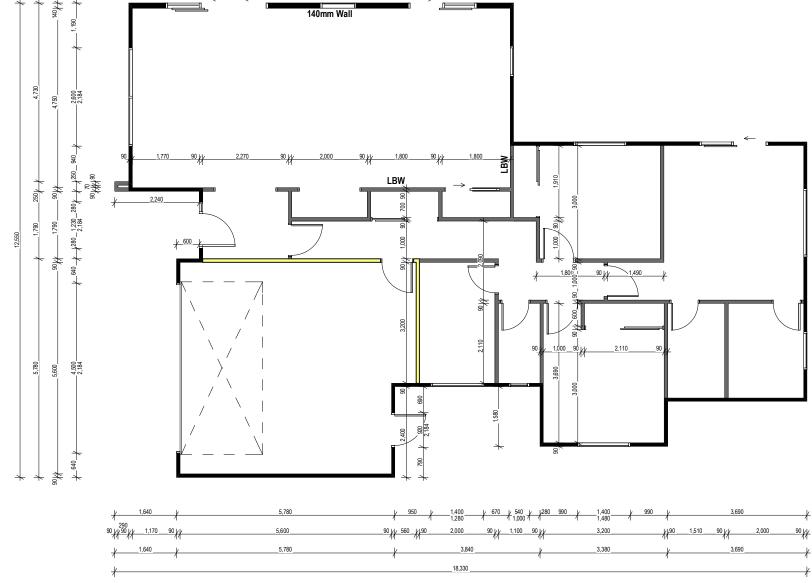

90 kh 600 khao

90 Jy

## **Ground Floor Framing Plan**

SCALE 1:100 @A3

Indicates insulated wall (R2.2 Batts) Indicates non-insulated wall Indicates insulated wall (R2.2 Batts)

Sizing of timber plates

Bottom Plate 45mm thick, width to match stud. SG8, H1.2, Pinus Radiata 45mm thick, width to match stud. Additional top plate 35mm thick, Top Plate 90mm wide if 90mm wall, 140mm wide if 140mm wall. SG8, H1.2,

All tiled areas to have dwangs @ 600mm crs. max. (Excludes skirting/upstands) Note: Gable ends clad in Brick to have studs @ 400mm ctrs

NOTE: Site located in sea-spray zone, all structural fixings to be type 304 stainless steel

LEGAL DESCRIPTION

NOTES: Subject to council approval All measurements to be confirmed on site by the contractor prior to the commencement of work

**APPROVED** NOTE: THE SCHEDULE OF FIXTURES AND FITTINGS TAKES PRESENCE OVER THESE BRAWING

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JOB TITLE:

**SHANKLAND** 

Framing Plan

DRAWING TITLE:

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Auckland

Proprietary 100mm Colorsteel spouting with concealed brackets @ 800mm crs max. fixed to Colorsteel fascia. (5,500mm² cross sectional area to spouting). With 80mm Dia Colorsteel Downpipes

All roof penetrations shall be flashed as per NZBC E2/AS1 external moisture section 8.4 profiled metal roof cladding (8.4.17 Roof Penetrations) as shown in figure 53 & 54

All Flashings to be 0.55 BMT Colorsteel fixed in accordance with NZS3604:2011 and meeting the durability requirements of NZBC E2/AS1 Table 20,21,22

### ROOF FRAMING:

All trusses to be designed & approved by a qualifed truss manufacturer able to issue a producer statement prior to building consent approval, which shall guarantee satisfactory performance within the parameters of this design.

Pitching height to be set at 2755mm above FFL.

### **FIXING NOTES:**

Purlins fixed to trusses with 1/10g x 80mm self-drilling screw or 2/100 x 3.75mm skewed nails & 1/wiredog. Top & bottom purlins shall be @ 600mm crs.

90x45mm H1.2 treated SG8 outriggers to gable verge to allow for 450mm overhang/eave width. Outriggers to span back to next truss.


Outriggers to be fixed as per NZS3604:2011 Table 10.18: - 1/10g x 80mm self-drilling screw to wall framing.

- 3/90 x 3.15mm nails to rafters.

- 4/90 x 3.15mm skewed nails to blocking.

Selected nail plate trusses @ 900mm crs max. fixed to top plate with 2/100 x 3.75mm skewed nails & 2/wiredogs each side.

Roof bracing to be 8.0kN diagonally opposed intersecting steel straps fixed to top chord & top plate as per NZS3604:2011, Section 10.3, 10.4

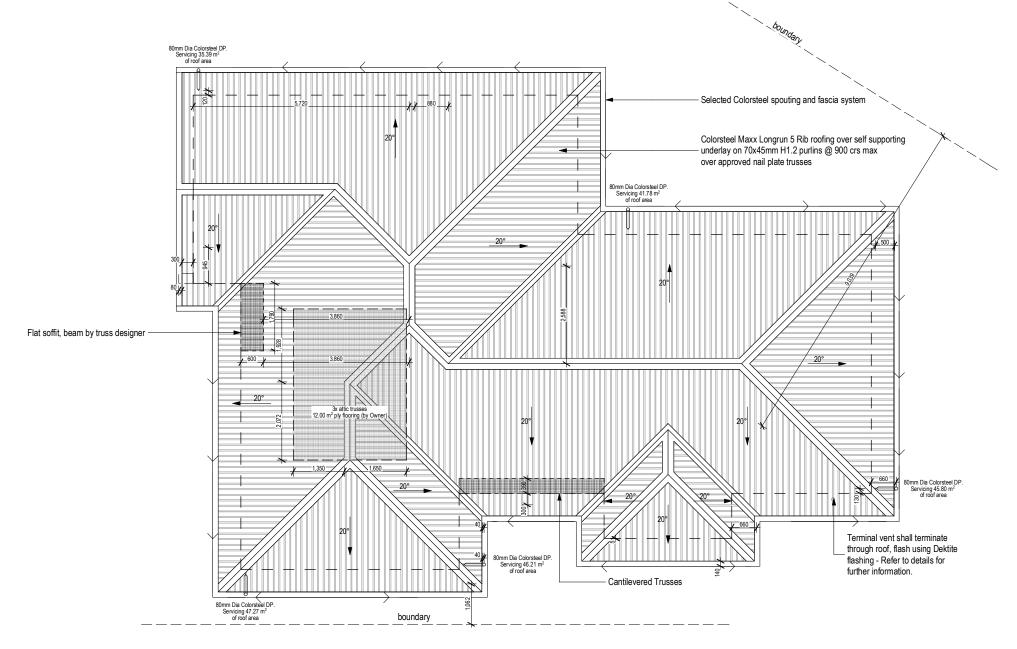

## Roof Plan

SCALE 1:100 @A3

Auckland 24/08/2018 BCO10269221 **APPROVED** 

NOTE: Site located in sea-spray zone, all structural fixings to be type 304 stainless steel

NOTE: THE SCHEDULE OF FIXTURES AND FITTINGS TAKES PRESEDENCE OVER THESE BRAWNS

**mikegreer**homes

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**SHANKLAND** 

DRAWING TITLE: Roof Plan

KAHAWAI POINT, GLENBROOK, AUCKLAND

NOTES: Subject to council approval
 All measurements to be confirmed on site by
the contractor prior to the commencement of work © 2017 Mike Greer Homes NZ Limited.

DATE OF ISSUE: 19/01/2018 AMENDMENT DATE: CM 23/03/2018

DESIGNER: SCALE: 1:100 A2.03 JOB#

LOT: 90 DP: tbc

LEGAL DESCRIPTION:

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TECHNICIAN: VERSION: CODE: SA243

### **BRACING NOTES:**

Where the distance between bracing lines at right angles to the plate is between 5.0m & 6.0m, the 90 x 45mm top plate shall be strengthened by the addition of a 140 x 35mm plate of at least the same grade as the top plate. Refer to


# Reading the Bracing Plan:


UB1S - 10mm Sheetrock on one side - 0.4m to 6.0m UB2S - 10mm Sheetrock on both sides - 0.4m to 4.8m EP1 - Ecoply one side with hold downs - 0.4m to 3.0m

UBMP - 10mm Multistop on one side 7mm DD structural plywood the other side with hold downs - 0.4m to 2.4m

### Openings in Bracing Elements:

Openings are allowed within the middle third of a wall bracing element's length & height. Neither opening dimension shall be more than one third of the element height. Wall linings are fixed to opening trimmers at 150mm crs. Small openings (e.g. power outlets) of 90 x 90mm or less may be placed no closer than 90mm to the edge of the braced

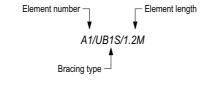

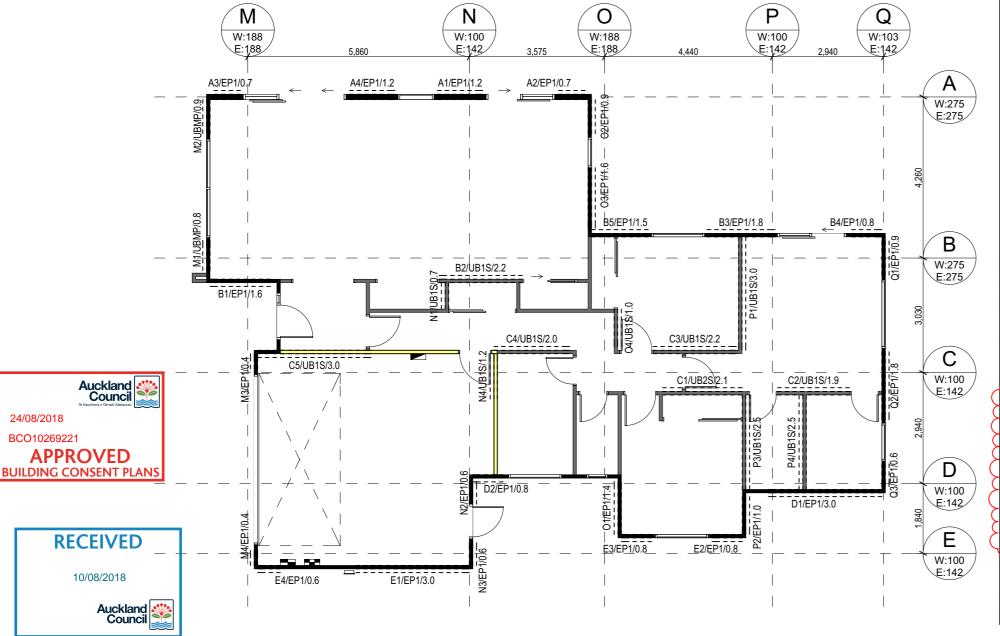

BRACING CALCULATIONS			
Location of Storey	Single	Floor Load	2kPa
Floor Height to Apex	5.0 m	Roof Weight	Light
Roof Height Above Eaves	2.0 m	Cladding Weights:	
Roof Pitch	0 - 25 °	- Subfloor	Concrete Floor
Roof Style	Gable	- Wall Cladding	Heavy
Building Length (BL)	18.0 m	Building Width (BW)	12.6 m
Room in Roof Space	0	Wind Zone	High
Soil Class	E - Very Soft	W along	55.0 BUs/m
Gross Plan Area (GPA)	166.8 m2	W across	50.0 BUs/m
Earthquake Zone	1	W along x BW	693.0 BUs
EQ	8.5 BUs/m2	W across x BL	900.0 BUs
EQ x GPA	1,417.5 BUs		
0 1 1 1 1 1 170000	1.0011		

Calculations are based on NZS3604:2011

ALONG
-------

Bracing	Line	Bracing Elements Provided					Wind Earthquake				
Line	Min BUs	Min BUs	Brace	Brace	Brace	Brace	Brace	Rating	BUs	Rating	BUs
Label	W	E	No.	Type	Length	Angle	Height	BUs/m	Achieved	BUs/m	Achieved
Α	275	275	A1	EP1 1.2	1.2	0.0	2.8	120	125.4	135	141.1
			A2	EP1 0.6	0.7	0.0	2.8	95	57.9	105	64.0
			A3	EP1 0.6	0.7	0.0	2.8	95	57.9	105	64.0
			A4	EP1 1.2	1.2	0.0	2.8	120	125.4	135	141.1
В	275	275	B1	EP1 1.2	1.6	0.0	2.8	120	167.3	135	188.2
			B2	UB1S-0.4	2.2	0.0	2.8	55	105.4	50	95.8
			B3	EP1 1.2	1.8	0.0	2.8	120	188.2	135	211.7
			B4	EP1 0.6	0.8	0.0	2.8	95	66.2	105	73.2
			B5	EP1 1.2	1.5	0.0	2.8	120	156.8	135	176.4
С	100	142	C1	UB2S-0.4	2.1	0.0	2.8	65	119.5	60	110.3
			C2	UB1S-0.4	1.9	0.0	2.8	55	91.0	50	82.8
			C3	UB1S-0.4	2.2	0.0	2.8	55	105.4	50	95.8
			C4	UB1S-0.4	2.0	0.0	2.8	55	95.8	50	87.1
			C5	UB1S-0.4	3.0	0.0	2.8	55	143.7	50	130.7
D	100	142	D1	EP1 1.2	3.0	0.0	2.8	120	313.6	135	352.8
			D2	EP1 0.6	0.8	0.0	2.8	95	66.2	105	73.2
E	100	142	E1	EP1 1.2	3.0	0.0	2.8	120	313.6	135	352.8
			E2	EP1 0.6	0.8	0.0	2.8	95	66.2	105	73.2
			E3	EP1 0.6	0.8	0.0	2.8	95	66.2	105	73.2
			E4	EP1 0.4	0.6	0.0	2.8	80	41.8	95	49.7
			•		Т	otals Ac	hieved:	W	2,473.7	Е	2,637.0
	Totals Required: W 693.0 E 1,417.5										

ı	•										1,417.5	
Ţ	ACROSS											
Γ	Bracing	Line		Bracing	Elements Pro			Wind		Earthqu	ake	
Γ	Line	Min BUs	Min BUs	Brace	Brace	Brace	Brace	Brace	Rating	BUs	Rating	BUs
L	Label	W	E	No.	Type	Length	Angle	Height	BUs/m	Achieved	BUs/m	Achieved
Γ	М	188	188	M1	EP1 1.2	0.8	0.0	2.8	120	83.6	130	90.6
				M2	UBMP<1200	0.9	0.0	2.8	120	94.1	130	101.9
				МЗ	EP1 0.4	0.4	0.0	4.0	80	19.4	95	23.1
$\lambda$	$\sim$	$\qquad \qquad \frown$		MA	VEDTOA	0.4	Q:0	40	80	19.4	95	23.1
(	Ν	100	142	N1	UB1S-0.4	0.7	0.0	2.8	55	33.5	50	30.5
	RFI 30	/07/2019		N2	EP1 0.4	0.6	0.0	2.8	80	41.8	95	49.7
(				N3	EP1 0.4	0.6	0.0	2.8	80	41.8	95	49.7
0				N4	UB1S-0.4	1.2	0.0	2.8	55	57.5	50	52.3
	0	188	188	01	EP1 1.2	1.4	0.0	2.8	120	146.4	135	164.6
				02	EP1 0.6	0.9	0.0	2.8	95	74.5	105	82.3
$\forall$				O3	EP1 1.2	1.6	0.0	2.8	120	167.3	135	188.2
7				04	UB1S-0.4	1.0	0.0	2.8	55	47.9	50	43.6
$\forall$	P	100	142	P1	UB1S-0.4	3.0	0.0	2.8	55	143.7	50	130.7
Н				P2	EP1 1.2	1.0	0.0	2.8	95	82.8	105	91.5
$\vdash$				P3	UB1S-0.4	2.5	0.0	2.8	55	119.8	50	108.9
J		$\sim$ 1	, ,	P4 1	UB1S-0.4	2.5	0.0	2.8	55	119.8	50	108.9
ľ	Q	103	142	Q1	EP10.6	0.9	0.0	<b>√</b> 2.8 <b>^</b>	95	74.5	105	\82.S\
				Q2	EP1 1.2	1.8	0.0	2.8	120	188.2	135	211.7
-				Q3	EP1 0.4	0.6	0.0	2.8	80	41.8	95	49.7
				_		Т	otals Ac	hieved:	W	1,597.7	E	1,683.0
Γ	Totals Required: W 900.0 E 1,417.5											

**Ground Floor Bracing Plan** 

SCALE 1:100 @A3

NOTE: Site located in sea-spray zone, all structural fixings to be type 304 stainless steel

NOTE: THE SCHEDULE OF FIXTURES AND FITTINGS TAKES PRECEDENCE OVER THESE DRAWINGS

**mikegreer**homes

24/08/2018 BCO10269221

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JOB TITLE: SHANKLAND

DRAWING TITLE: **Bracing Plan** 

LEGAL DESCRIPTION: LOT: 90 DP: tbc KAHAWAI POINT, GLENBROOK, AUCKLAND

NOTES: Subject to council approval
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### **ELECTRICAL NOTES**

- Allow for single switched powerpoint for standard appliances: Fridge, Dishwasher, Waste Disposal, Rangehood, Hob, Oven, Refer to kitchen design for layout and positions of kitchen area sockets etc. All power points are indicative only and must be positioned and confirmed on site by architect and/or owner.
- All electrical installations to be in accordance with NZECP 51:2001
- Mesh in floor slab must be earthed, earth with 16mm REO rod brought up into garage wall below meterbox and wired to the mesh. At prewire, connect a clamp and piece of wire to rod and earth it to the meterbox.
- Where downlights are to be installed, only CA 80, CA 135, IC or IC-F downlights are permitted in private or rental dwellings. (Note that IC downlights can only be used with insulation that passes the needle flame test of AS/NZS 60598 2.2 clause 11.5). Recessed downlights that are not labelled as above are not permitted to be installed into residential buildings.
- · Total of 20 lux of illuminance for the total wattage required per m2 of floor area as shown in NZBC G8 / AS1 Table 1.
- Lighting and electrical by others, all positions and types to be selected and confirmed by client with contractor unless noted otherwise.
- Mechanical ventilation in housing removing moisture shall be vented outside (includes wet areas & cooker hoods). Refer to NZBC G4/AS1 1.3.C.iio, Mechanical Ventilation to be 150 dia 230 Cu M/H inline fan ducted to soffit. Auto extractor fans shall terminate through wall/soffit/roof with an extraction rate as set out in NZBC G4.
- All smoke alarms are to comply with NZBC F7 and be manufactured to at least one of: AS 3786, ISO 12239 or BS EN 14604, Required within 3m of all sleeping areas, change in level & entry/exits as per NZS 4514 & BRANZ Bulletins No's 252 & 309

-Downlights shall be CA80 check the insulation manufacturers instructions to ensure their product is safe when installed along side proposed downlights

### **GENERAL PLACEMENT NOTES**

- Powerpoints typically 300mm from nearest corner & 300mm from FFL unless
- Powerpoints in wet areas to be 1,200mm high from FFL and vertically fixed


-Powerpoint for heater to be located 300mm below finished ceiling level

- -Powerpoints in kitchen to be 1000mm high from FFL
- Light switches typically 150mm from nearest corner or door frame & 1,200mm from FFL unless otherwise noted.

-HWC switch 300mm above FFL

-Laundry Power Point 1000mm above FFL

House to be wired for alarm with key pad @ entrance and garage

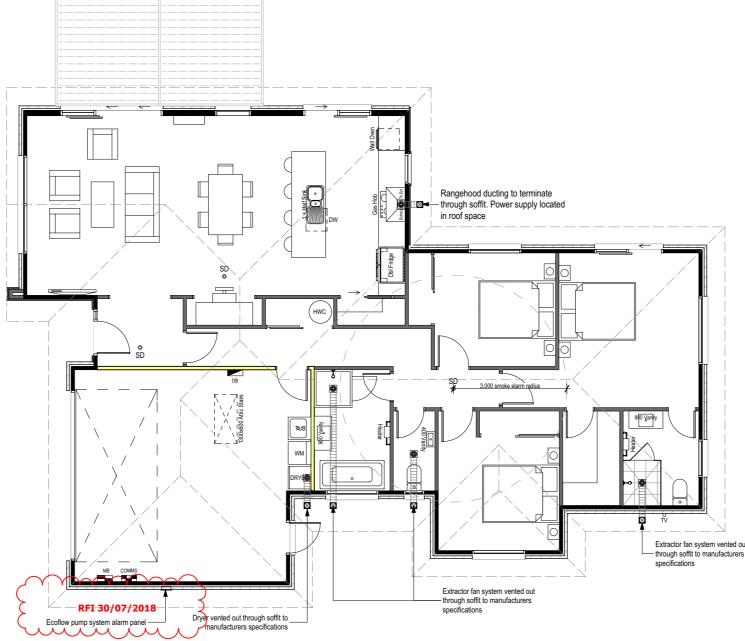

### **ELECTRICAL LEGEND**

Meterboard / Earth

Distribution Board

Smoke Detector

Heated Towel Rail

Communications Panel

Hot Water Cylinder (HWC)

Bathroom Heater

 $\boxtimes$ Outlet Grille

Mechanical Vent / Ducting

Extract Grille

## **Ground Floor Electrical Plan**

SCALE 1:100 @A3



NOTE: Site located in sea-spray zone, all structural fixings to be type 304 stainless steel

LEGAL DESCRIPTION:

KAHAWAI POINT, GLENBROOK, AUCKLAND

### NOTE: THE SCHEDULE OF FIXTURES AND FITTINGS TAKES PRECEDENCE OVER THESE DRAWINGS

24/08/2018

BCO10269221

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**SHANKLAND** 

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NOTES:

DATE OF ISSUE: DESIGNER: SCALE: 19/01/2018 TECHNICIAN: AMENDMENT DATE: CM JOB# VERSION: CODE: SA243 23/03/2018

**APPROVED** 

BUILDING CONSENT PLANS


Auckland


Council

DRAWING TITLE: **Electrical Plan** 

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A2.05



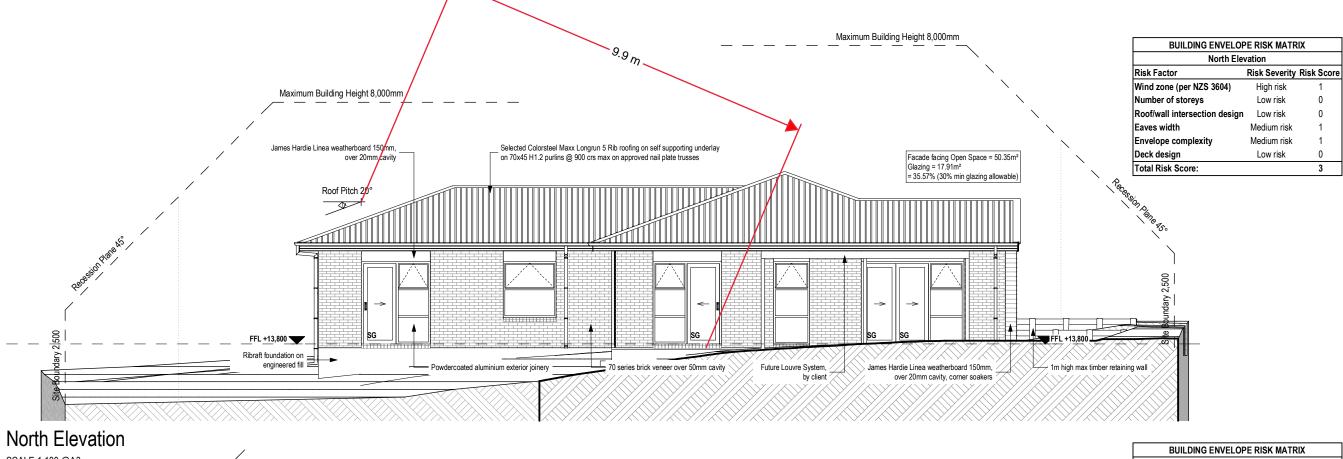

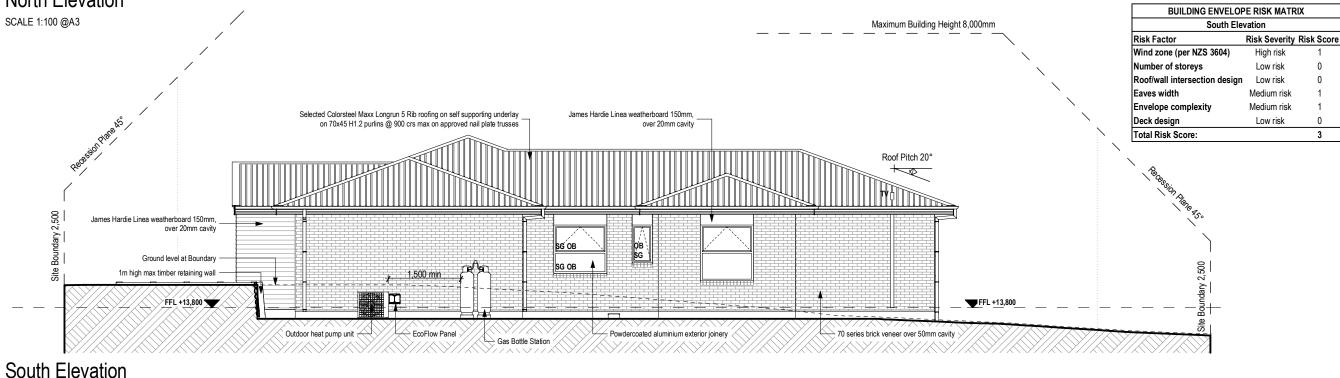Glazing and glazed openings to comply with NZS 4223.3:2016 Glazing in buildings -Part 3: Human impact safety requirements, NZS 4211:2008: Specification for preformance of windows and New Zealand Building Code Clauses: F2 Hazardous Building Materials & F4: Safety from Falling.

SCALE 1:100 @A3

NOTE: Site located in sea-spray zone, all structural fixings to be type 304 stainless steel

NOTE: THE SCHEDULE OF FIXTURES AND FITTINGS TAKES PRESEDENCE OVE

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**SHANKLAND** 

DRAWING TITLE: **Elevations** 

LOT: 90 DP: tbc KAHAWAI POINT, GLENBROOK, AUCKLAND

LEGAL DESCRIPTION

NOTES: Subject to council approval
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DATE OF ISSUE: 19/01/2018 AMENDMENT DATE: CM 23/03/2018


DESIGNER: SCALE: 1:100 TECHNICIAN: A3.01 JOB# VERSION: CODE: SA243

24/08/2018

BCO10269221

**APPROVED** 

Auckland &

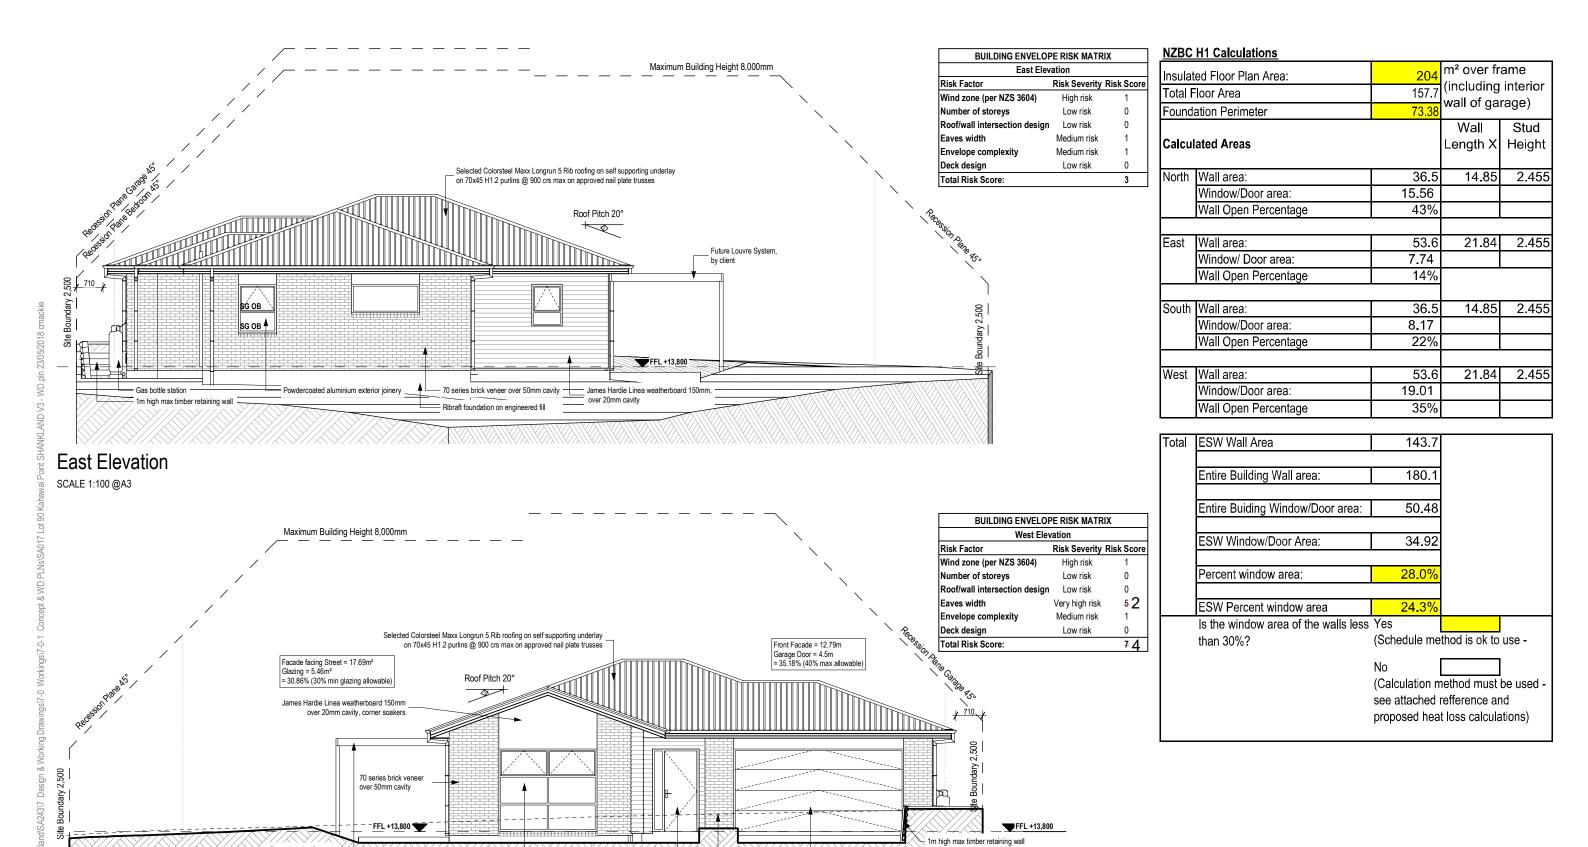

Ground level at Boundary

## West Elevation

SCALE 1:100 @A3

Glazing and glazed openings to comply with NZS 4223.3:2016 Glazing in buildings -Part 3: Human impact safety requirements, NZS 4211:2008: Specification for preformance of windows and New Zealand Building Code Clauses: F2 Hazardous Building Materials & F4: Safety from Falling.

Powdercoated aluminium exterior joinery

NOTE: Site located in sea-spray zone, all structural fixings to be type 304 stainless steel

Selected Colorsteel textured flat panel

sectional garage door

24/08/2018 BCO10269221 **APPROVED** NOTE: THE SCHEDULE OF FIXTURES AND FITTINGS TAKES PRESEDENCE SVEN

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**SHANKLAND** 

JOB TITLE:

DRAWING TITLE: **Elevations** 

Parkwood Fibreglass front door in PC aluminium frame, sidelight

> LOT: 90 DP: tbc KAHAWAI POINT, GLENBROOK, AUCKLAND

LEGAL DESCRIPTION

NOTES: Subject to council approval
 All measurements to be confirmed on site by
the contractor prior to the commencement of work © 2017 Mike Greer Homes NZ Limited.


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DATE OF ISSUE: DESIGNER: 19/01/2018 TECHNICIAN: AMENDMENT DATE: CM VERSION: CODE: 23/03/2018

SCALE: 1:100 A3.02 JOB# SA243

Auckland



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**SHANKLAND** 

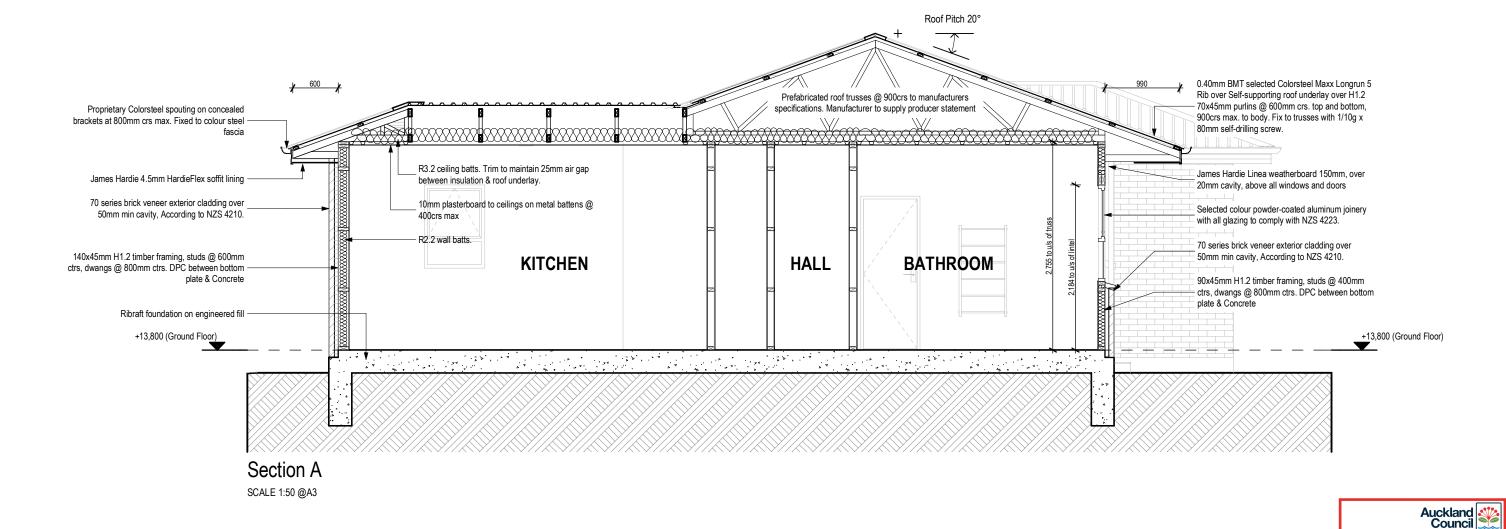DRAWING TITLE:

**Cross Section** 

LEGAL DESCRIPTION: LOT: 90 DP: tbc

NOTE: Site located in sea-spray zone, all structural fixings to be type 304 stainless steel

NOTES: Subject to council approval
 All measurements to be confirmed on site by
the contractor prior to the commencement of work


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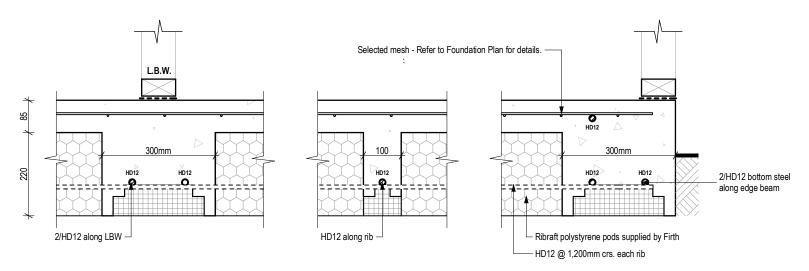
24/08/2018 BCO10269221

**APPROVED** 

KAHAWAI POINT, GLENBROOK, AUCKLAND


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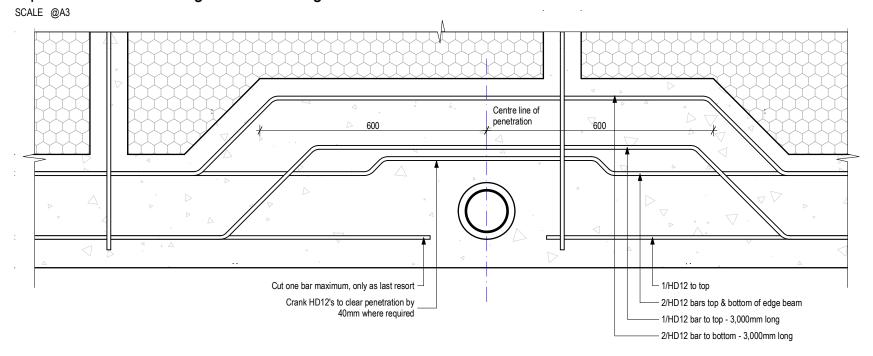


## RibRaft Beams

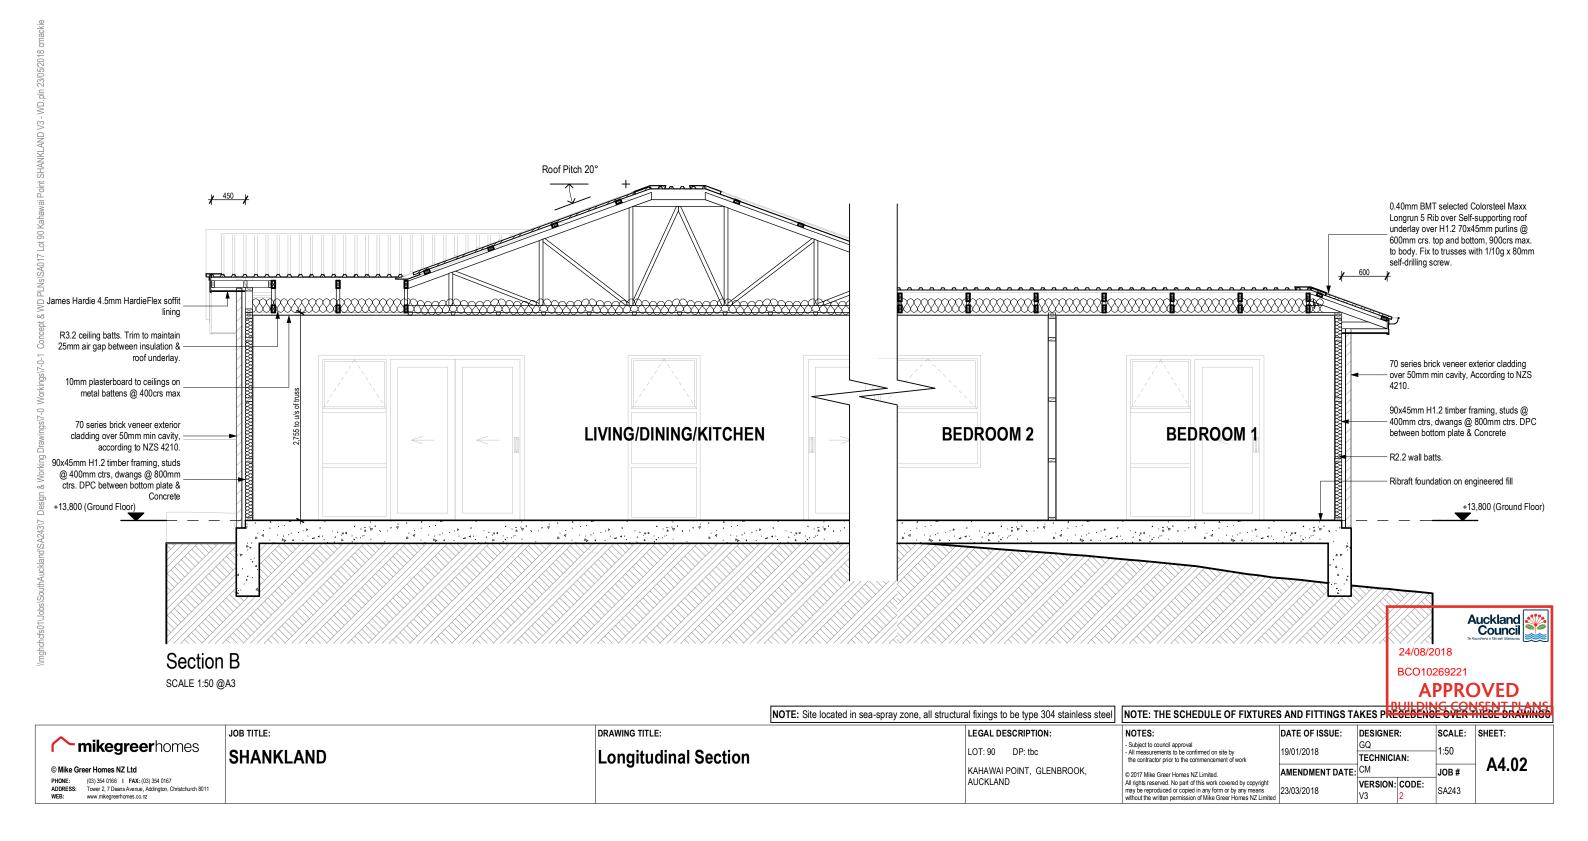SCALE @A3




## Pipe Penetration Through Slab and Edge beam

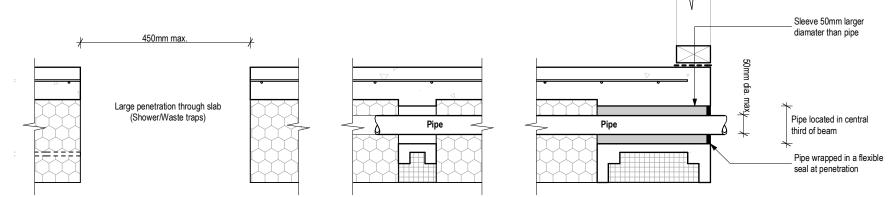

## Vertical Pipe Penetration Through Edge Beam


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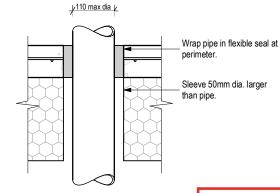


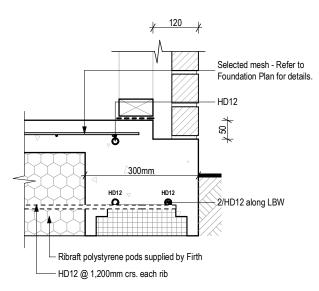

## **Brick Rebate**

SCALE @A3



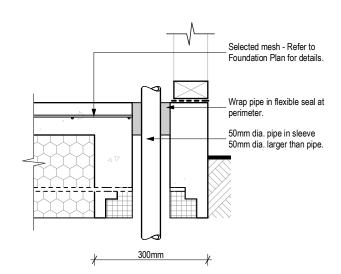

Auckland Council

Pipe Penetration Through Slab ar d Edge beam APPROVED NOTE: THE SCHEDULE OF FIXTURES AND FITTINGS TAKES PRESEDENCE OF SIXTURES AND FITTINGS TAKES PRESEDENCE OF THE SCHEDULE OF FIXTURES AND FITTINGS TAKES PRESEDENCE OF THE SCHEDULE OF TAXABLE PRESEDENCE OF THE SCHEDULE OF TAXABLE PRESEDENCE OF TA

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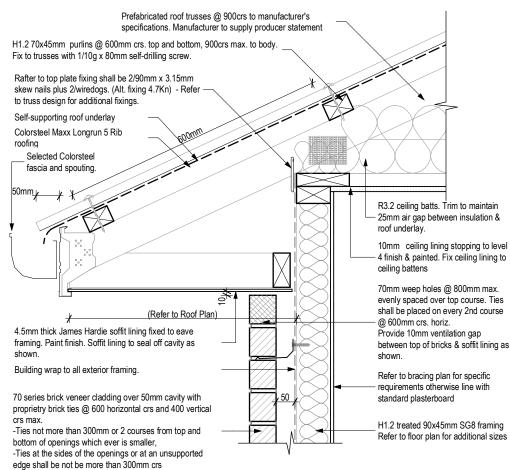
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**SHANKLAND** 

## 70 Series Brick - Barge

SCALE 1:10 @A3



## 70 Series Brick - Typical Soffit Detail

SCALE 1:10 @A3



**SHANKLAND** 

**Details** 

# LEGAL DESCRIPTION

KAHAWAI POINT, GLENBROOK,

# NOTES:

Subject to council approval
 All measurements to be confirmed on site by
the contractor prior to the commencement of work

NOTE: THE SCHEDULE OF FIXTURES AND FITTINGS TAKES PRESEDENCE OVER THESE BRAWING DESIGNER: SCALE: 1:10, 1:5 19/01/2018 TECHNICIAN: A5.02


24/08/2018

### - x 2.8mm dia. HardieFlex nails @ 800mm crs max. according to 0 @ 600 horizontal crs and 400 vertical crs max. -Ties not more than 300mm or 2 courses from top and manufacturers specification bottom of openings which ever is smaller, James Hardie Scyon Linea Board fixed in accordance -Ties at the sides of the openings or at an unsupported with manufacturer's specifications. Refer to supporting edge shall be not be more than 300mm crs documents for further information. Self-supporting building wrap to all exterior framing. H1.2 treated 90x45mm SG8 framing Refer to floor plan for addition sizes Insulation batts

Suitable size pre primed scriber sealed to brick with flexible sealant

H3.2 20mm timber cavity battens fixed @ stud crs. with 40mm

## 70 Series Brick - Cladding Junction (Linea Weatherboard)

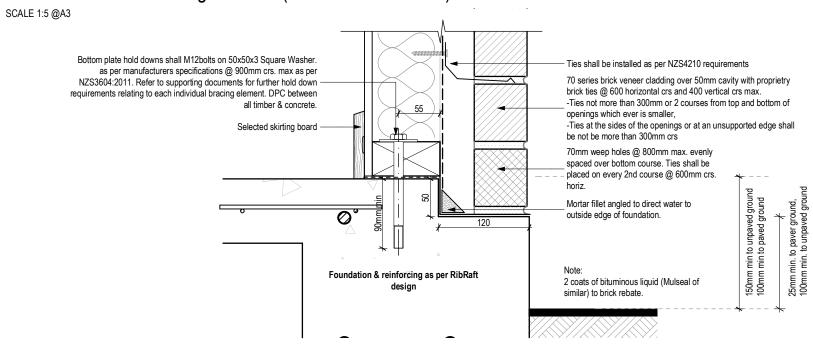

### 70 Series Brick - Foundation

70 series brick veneer cladding with proprietry brick ties

Refer to bracing plan for specific requirements otherwise

line with standard plasterboard.

SCALE 1:5 @A3

Pre-primed timber scriber cut to fit selected James Hardie Scyon Linea Board fixed in accordance with manufacturers specifications. H3.2 20mm timber cavity battens fixed @ stud crs. with 40mm x 2.8mm dia. HardieFlex nails @ 800mm crs max. according to manufacturers specification.

Building wrap to all exterior framing H1.2 treated 90x45mm SG8 framing

Refer to floor plan for addition sizes Insulation batts

Refer to bracing plan for specific requirements

otherwise line with standard plasterboard

Linea Weatherboards - Window Jamb Detail

BCO10269221

Line of head flashing above,

MS silicone sealant between

Axent trim & aluminium joinery.

Selected colour powder-coated

Double glazing to all except

service areas and garage.

Flashing tape installed to manufacturers specifications

H3.1 treated 20mm pine

aluminium joinery with all glazing to comply with NZS 4223.

Continuous air seal over PEF rod

extends past scriber min 10mm

**APPROVED** 

Auckland 4

Council

NOTE: Site located in sea-spray zone, all structural fixings to be type 304 stainless steel


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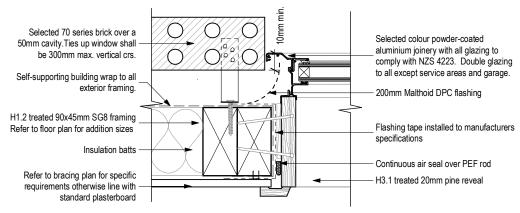
## 70 Series Brick - Garage Door Jamb

SCALE 1:5 @A3




70 Series Brick - Garage Door Rebate

SCALE 1:10 @A3

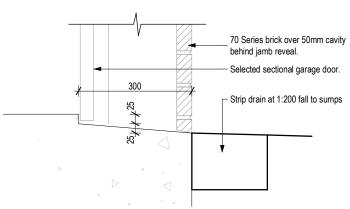


## 70 Series Brick - Window Jamb Detail

SCALE 1:5 @A3

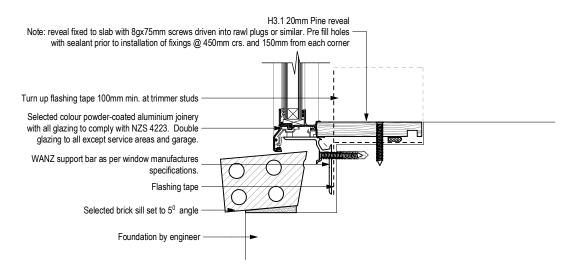


## 70 Series Brick - Typical Sill

SCALE 1:5 @A3

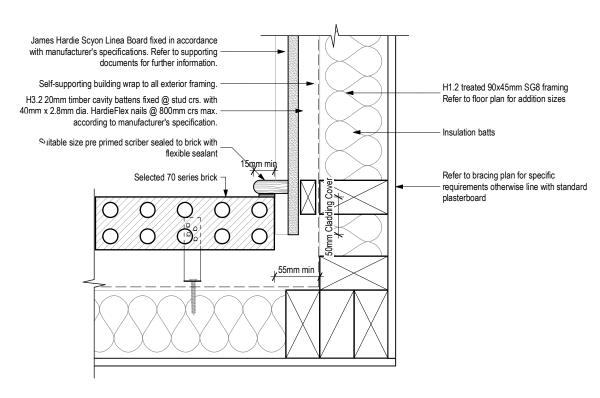

## 70 Series Brick - Cladding Junction (Linea Weatherboard)

SCALE 1:5 @A3

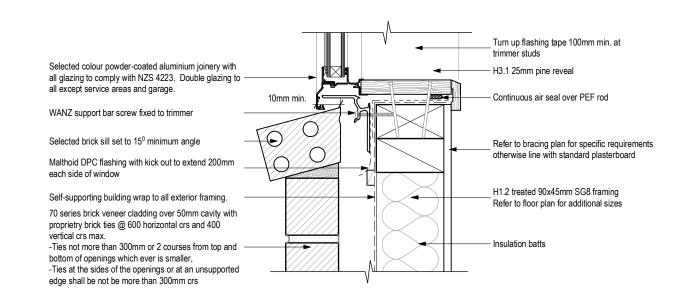

## 70 Series Brick - Window Sill Detail

SCALE 1:5 @A3

Auckland 24/08/2018 BCO10269221 **APPROVED** NOTE: THE SCHEDULE OF FIXTURES AND FITTINGS TAKES PRESEDENCE OVER THESE DRAWING

NOTE: Site located in sea-spray zone, all structural fixings to be type 304 stainless steel

LEGAL DESCRIPTION NOTES:

- Subject to council approval All measurements to be confirmed on site by the contractor prior to the commencement of work

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SCALE: 1:5, 1:10 JOB#

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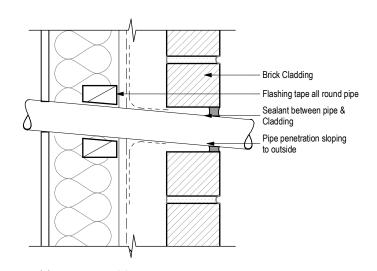
DRAWING TITLE:

**Details** 

KAHAWAI POINT, GLENBROOK,


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TECHNICIAN: VERSION: CODE: SA243 A5.03




# 70 Series Brick - Pipe Penetration

SCALE 1:5 @A3

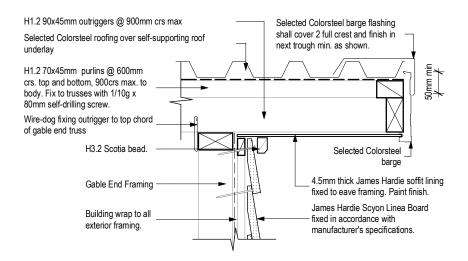


## Linea Weatherboards - Barge

SCALE 1:10 @A3

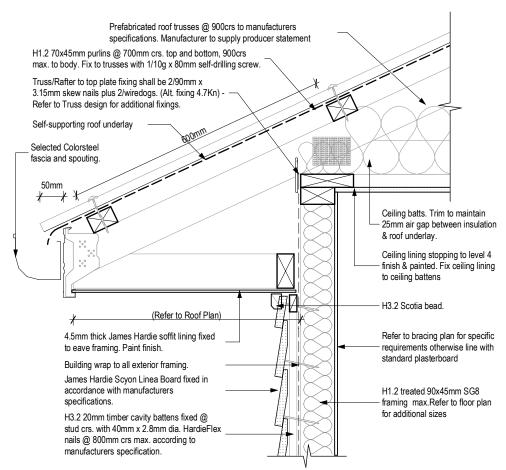


## Linea Weatherboards - Typical Soffit

SCALE 1:10 @A3

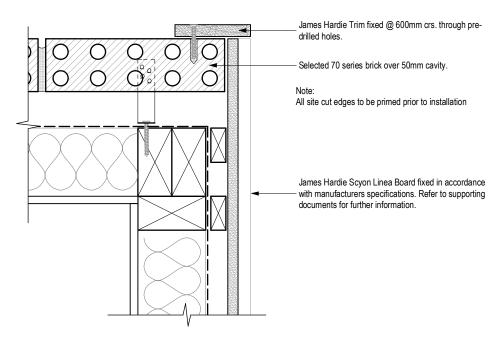


70 Series Brick - Cladding Junction (Linea Weatherboard)

SCALE 1:5 @A3

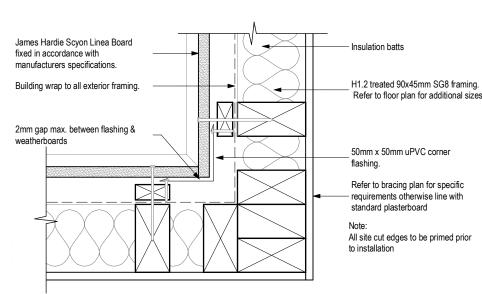

Linea Weatherboards - Internal Corner

SCALE 1:5 @A3

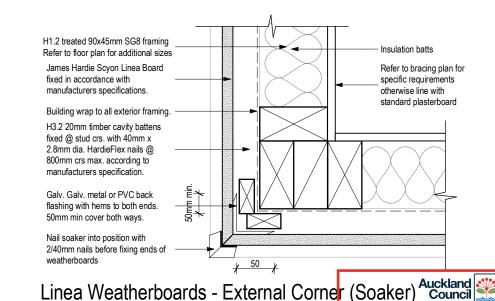

NOTE: Site located in sea-spray zone, all structural fixings to be type 304 stainless steel

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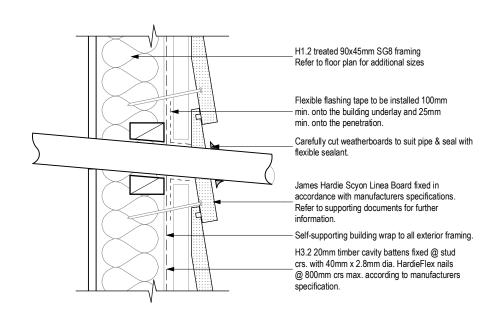
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SCALE 1:5 @A3


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## Linea Weatherboards - Pipe Penetration

SCALE 1:5 @A3



## Linea Weatherboards - Foundation

SCALE 1:5 @A3
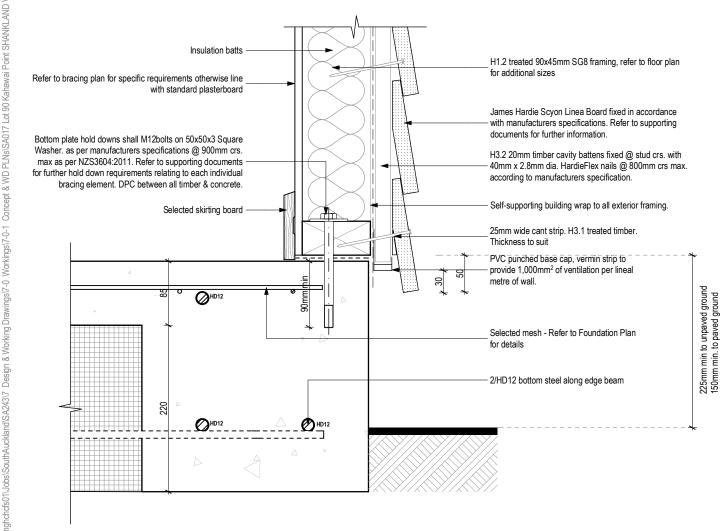
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Auckland

supply producer statement H1.2 90x45mm outriggers @ 900mm crs max 4.5mm thick James Hardie soffit lining fixed to raking soffit. Paint finish. Colorsteel flashing with 5mm kickout. Connect top plate to exterior wall with 2mm thick galv. nail plate fixed with 6/30 x 3.15mm nails per side achieving 6 kN. H1.2 treated 90x45mm SG8 framing Refer to floor plan for addition sizes

2mm thick galv. nail plate fixed with 6/30 x 3.15mm nails per side achieving 6 kN.

Linea Weatherboards - Raking Soffit

H3.1 20mm timber cavity battens fixed @ stud crs. with 40mm x 2.8mm dia.

according to manufacturers specification

James Hardie Scyon Linea Board fixed in

Colorsteel Head flashing to extend 50mm

HardieFlex nails @ 800mm crs max.

Self-supporting Building Wrap

accordance with manufacturers

min behind soffiting lining

SCALE 1:5 @A3

0.40mm BMT selected corrugated coloursteel

Prefabricated roof trusses behind @ 900crs to

manufacturers specifications. Manufacturer to

roofing over Self-supporting roof underlay

specifications.

NOTE: Site located in sea-spray zone, all structural fixings to be type 304 stainless stee

Linea Weatherboards - Garage Door Head

NOTE: THE SCHEDULE OF FIXTURES AND FITTINGS TAKES PRESEDENCE OVER THESE BRAWING

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H1.2 timber lintel, in accordance with Truss Design. Refer to truss manufacturer

documents and floor plans for sizes.

Flashing tape installed to manufacturers

H3.1 packing @ fixing crs with Continuous

specifications

air seal over PEF rod

H1.2 70x45mm purlins @ 600mm crs. top and bottom, 900crs max.


to body. Fix to trusses with 1/10g x 80mm self-drilling screw.

H3.1 treated 20mm pine reveal

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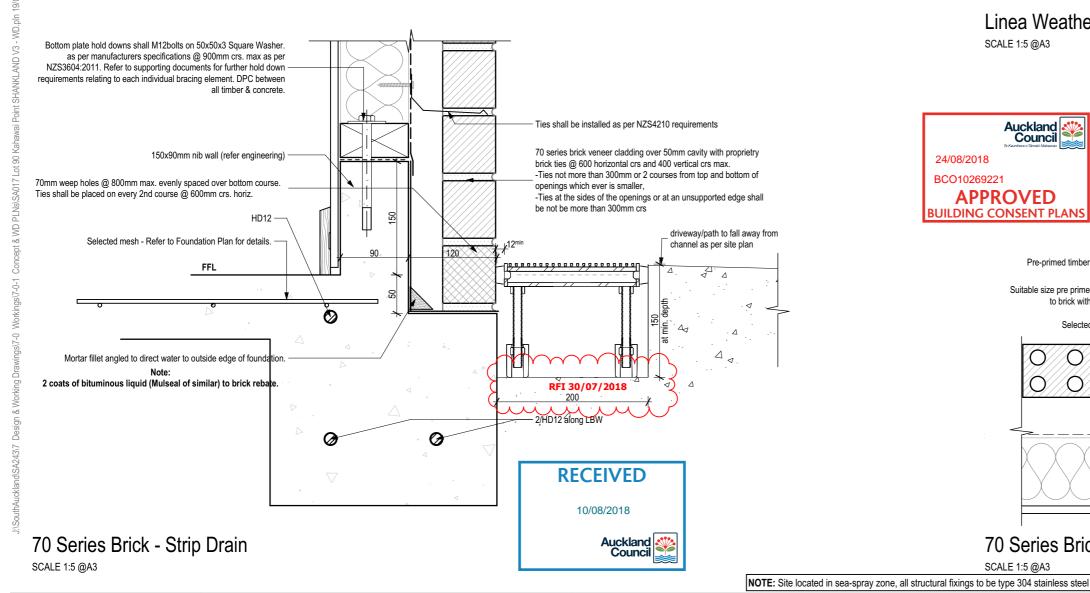
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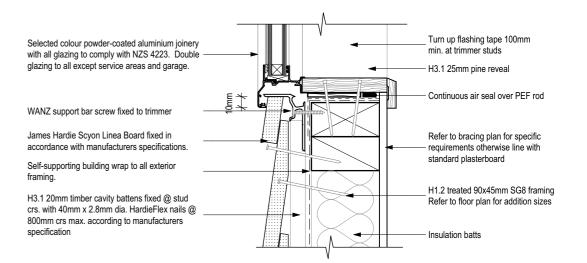
**Details** 



### Linea Weatherboards - Window Head Detail

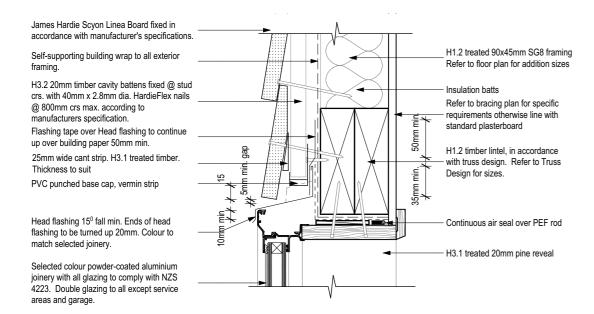
SCALE 1:5 @A3





### Linea Weatherboards - Window Sill Detail

SCALE 1:5 @A3

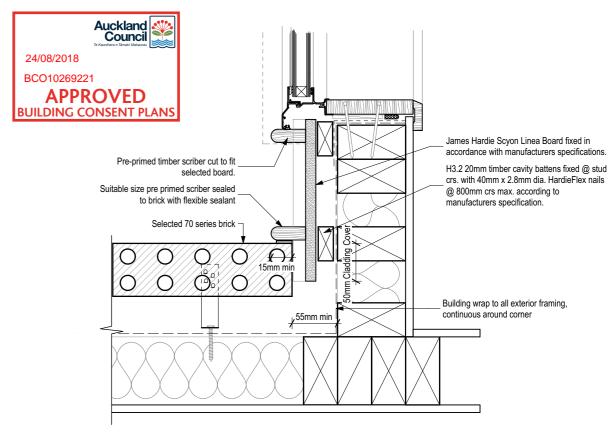

## 70 Series Brick - Cladding Junction at Entry

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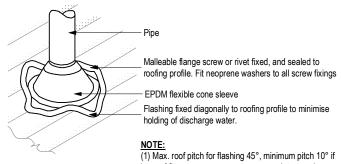
**Details** 

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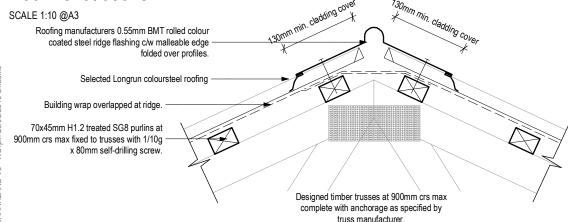
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SA243 23/03/2018




base of flange covers one or more complete troughs. (2) For pipes up to 85mm dia.


## **Roof Penetrations**



## Ridge Capping Details

SCALE 1:10 @A3

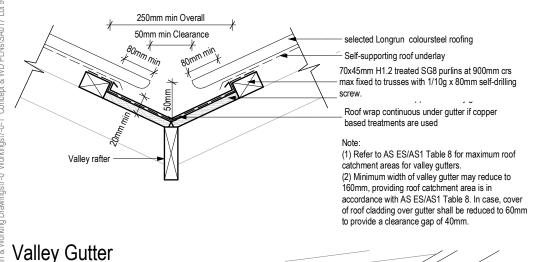

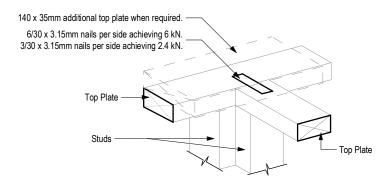

### CONNECTING TOP PLATES TO EXTERNAL WALLS - WALLS CONTAINING BRACING

NOTE: Each wall that contains one or more wall bracing elements shall be connected at top plate level, either directly, or through framing member in the line of the wall, to external walls at nails at 600crs. with 2/100 x 3.75 mm right anlgles to it. Top plate fixing of the capacity in tension or compression along the line of the wall bracing element are given as below"

(a) For each wall containing bracing elements with a total of not more than 250 BUs, the fixing capacity shall be 6 kN.


(b) For each wall containing bracing elements with a total of more than 250 BUs, the fixing Refer to NZS 3604:2011 clause 8.7.3.4

## **Top Plate Bracing**

SCALE 1:10 @A3 Selected Cladding Downpipe brackets fixed to Cladding with appropriate toggle fasteners. FFL Downpipe to be sealed if within 500mm of gas water heater or meter 100Ø riser to extend to bottom of cladding.

## **Downpipe Corner Offset**

SCALE 1:10 @A3

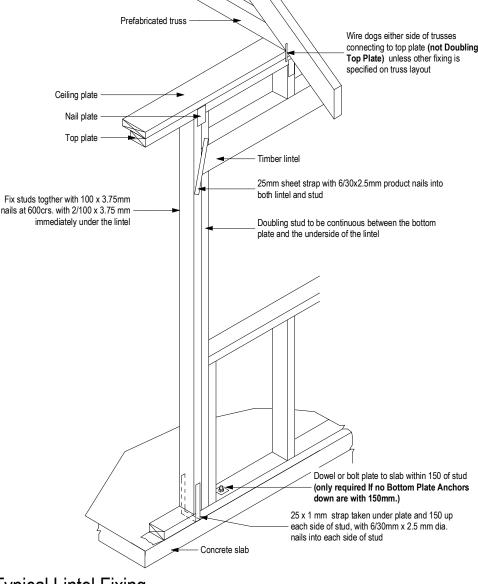

**Typical Lintel Fixing** 

SCALE 1:20 @A3

## SCALE 1:10 @A3 For other ridge to hip flashings, refer to New Zealand

Metal Roof and Wall Cladding code of practice

Butyl under-flashing to ridge and hip flashings Preformed 3-way roll cap or site made flashing

Soft edge dressed over corrugate



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Ridge flashing

Soft edge dressed over corrugate

NOTE: Site located in sea-spray zone, all structural fixings to be type 304 stainless steel

Refer to foundation plan for

location of downpipes.

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NOTES:


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Gully Trap SCALE 1:50 @A3

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with male trap connector and backnut

Where internal waste pipe runs are too long to discharge above the GT then the above detail applies

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Details

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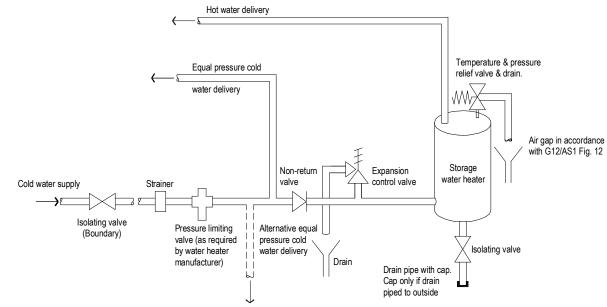
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LOT: 90 DP: tbc AUCKLAND
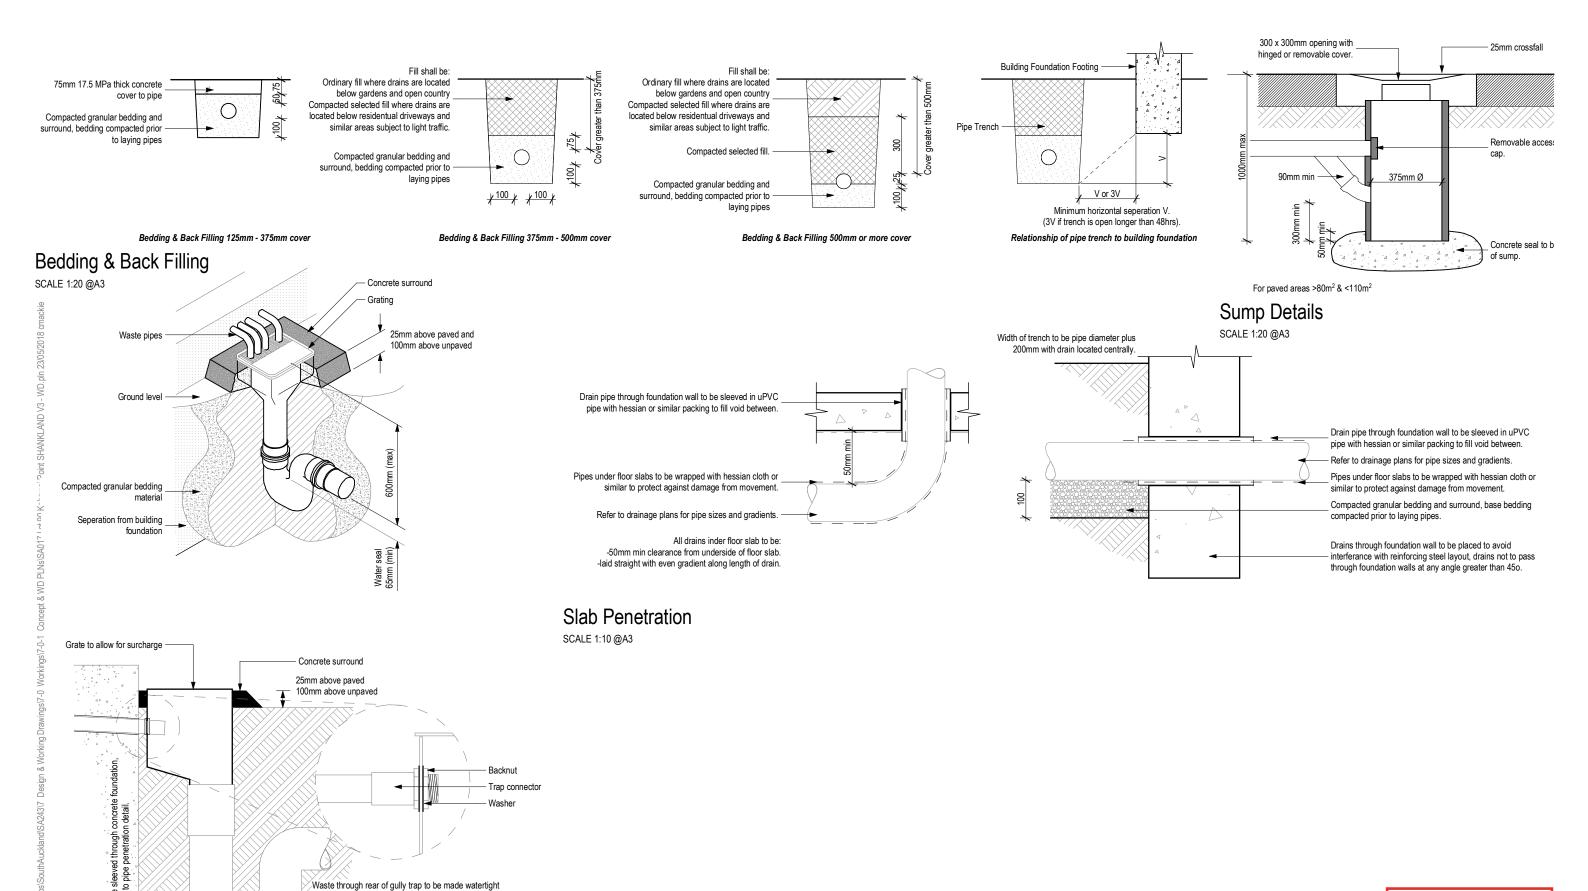
### 70 Series Brick - Ecoflow CP Unit

SCALE 1:5 @A3



## Hotwater Schematic Diagrams

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SCALE 1:50 @A3

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Light timber framed wall complying

with NZS 3604

DESIGNER: SCALE: 1:50, 1:5 A5.09 JOB#

SA243


### NOTE: Site located in sea-spray zone, all structural fixings to be type 304 stainless steel JOB TITLE: DRAWING TITLE: LEGAL DESCRIPTION **mikegreer**homes SHANKLAND Details


Storage water heaters to be restrained with 25 x 1mm galvanised steel straps tensioned when fixed in place. Straps to be fixed to wall framing with: - 1 No. 8mm coach screw with 30 x 2mm thick washer, or - 2 No. 20 x 2.5mm thick washers. 100mm Screws to penitrate timber framing a minimum of 50mm. Storage Wate Extra centre strap for water heaters exceeding 200 litres. 100mm - Blocking within wall framing max - 40dia overflow 25mm airgap between relief drain & flood rim of trav. 50 x 50mm vertical blocking full height of water heater, fixed to wall framing with 1 No. 100 x 3.75mm nail at 600 crs maxaccording to Storage Water Storage manufacturers specification. Water Heater

> 25mm airgap between relief drain & flood rim of tray.

## **HWC Restraint Diagram**

SCALE 1:50 @A3

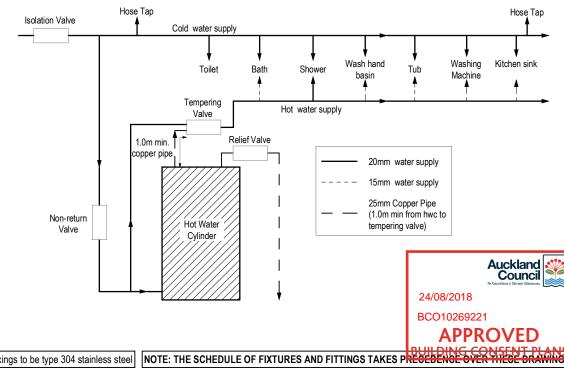

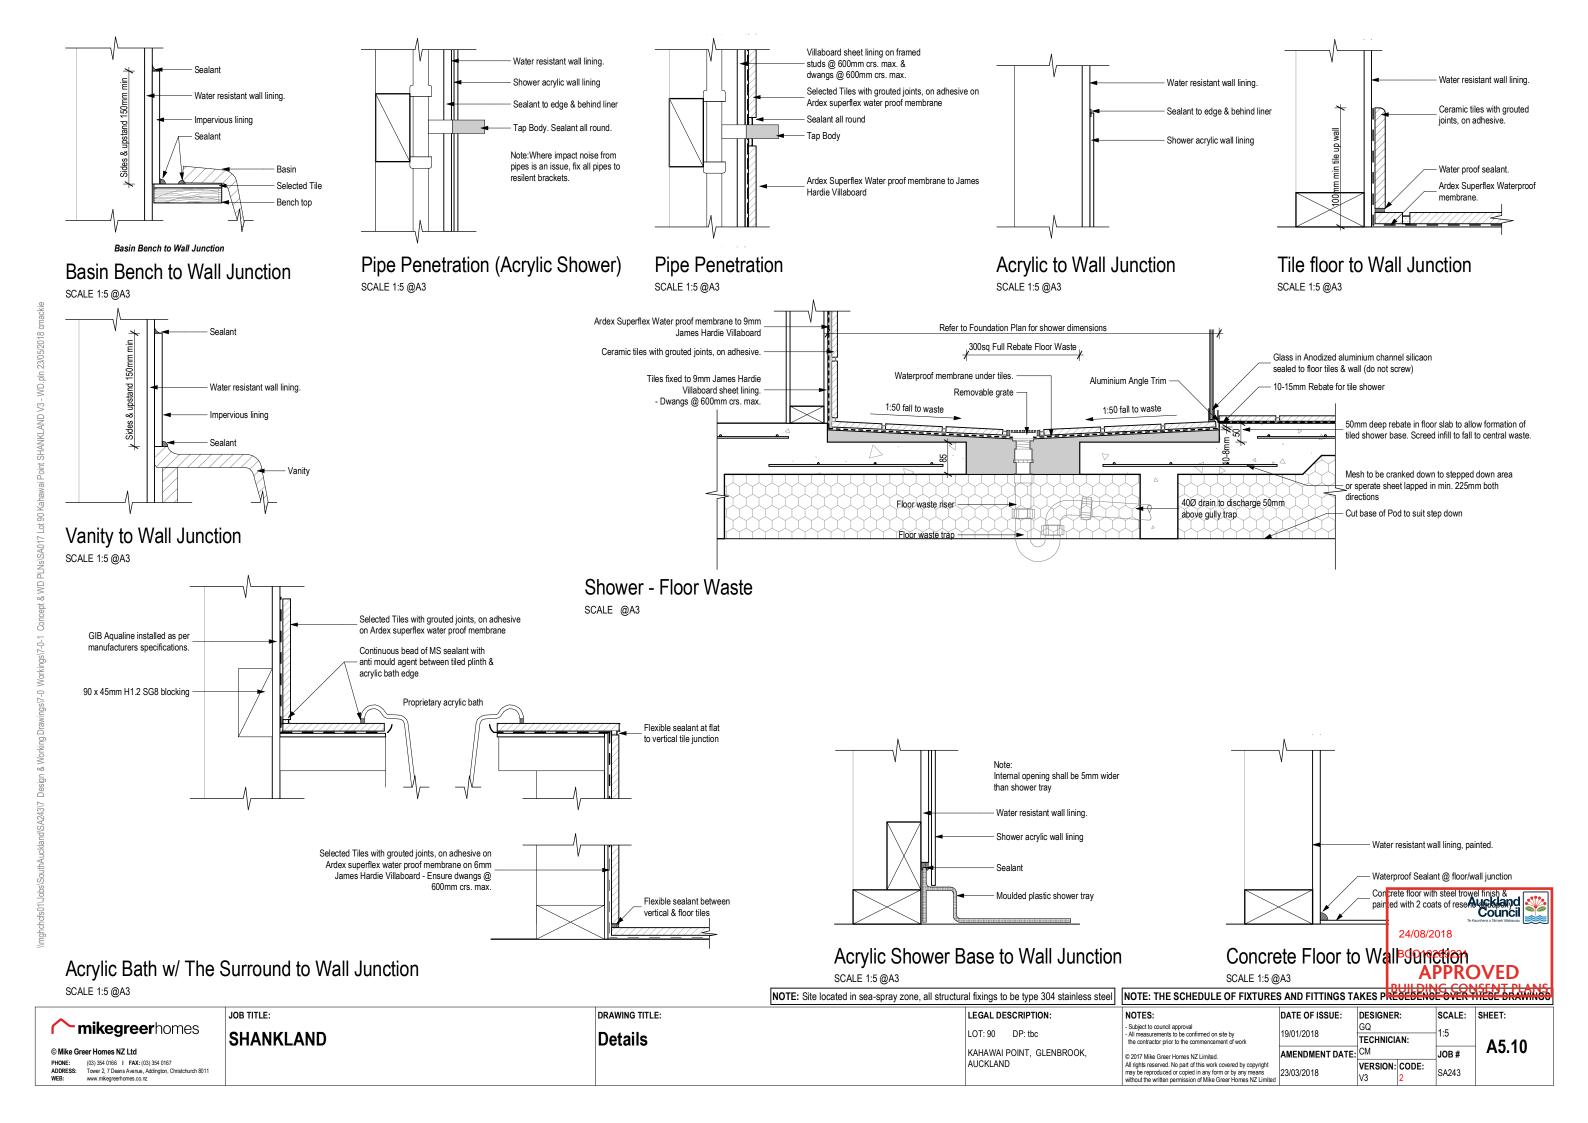

-All exterior window and doors to be colorsteel powdercoated aluminium framed with Joinery:

double glazing and dressed timber reveals unless noted otherwise. Refer to

specification for full details.

-Internal Door Leaf Height: -Standard.

-Internal Door Leaf Width: -Typically 810mm (unless noted on plan).

-Typically 710mm (wet areas).

-Garage Door: -Coloursteel sectional

-Refer to the Truss Design for lintel sizes. -Lintels:

-Safety Glazing (SG): -To all windows less than 500mm above FFL, unless a transom is less than

1.0m from FL.

-To all windows in wet areas less than 1.6m above FFL.

-To all doors (bottom pane only where a transom is used.)

Obscure Glazing (**OB**): -To Bathroom, Wc and Ensuite

All doors & sliders are taken from External Elevation. All windows are taken from External Elevation.

Window & Door Layout Plan takes precendence over Window Schedule - Refer to Plan & Elevations for opening direction.

Glazing and glazed openings to comply with NZS 4223.3:2016 Glazing in buildings - Part 3: Human impact safety requirements, NZS 4211:2008: Specification for preformance of windows and New Zealand Building Code Clauses: F2 Hazardous Building Materials & F4: Safety from Falling.

### Standard glazing units used


All Double Glazed Units Comply with Table G2, NZS 4218:2004 & meet 0.26 (msqo C/W)

4mm Glass / 12mm Air Gap / 4mm Glass

5mm Glass / 8mm Air Gap / 5mm Glass

Safety Panel 4mm Toughened / 8mm Air Gap / 6.38mm Laminate

Ventilation:		Vented Area/Room Area		Natural Light:	Window Area/Room Area				
Rooms	Window Area (Vented)	Room Area	Total	Rooms	Window Area (Glazed)	Room Area	Total		
LIVING	3.33	22.68	15%	LIVING	5.33	22.68	24%		
BEDROOM 1	3.1	14.02	22%	BEDROOM 1	3.48	14.02	25%		
BEDROOM 2	2.33	11.1	21%	BEDROOM 2	2.71	11.1	24%		
BEDROOM 3	2.34	10.2	23%	BEDROOM 3	2.34	10.2	23%		
BEDROOM 4	1.72	10.6	16%	BEDROOM 4	1.72	10.6	16%		
LOUNGE	1.26	16.8	8%	LOUNGE	3.54	16.8	21%		
KITCHEN/DINING	4.08	12.28	33%	KITCHEN/DINING	4.66	12.28	38%		

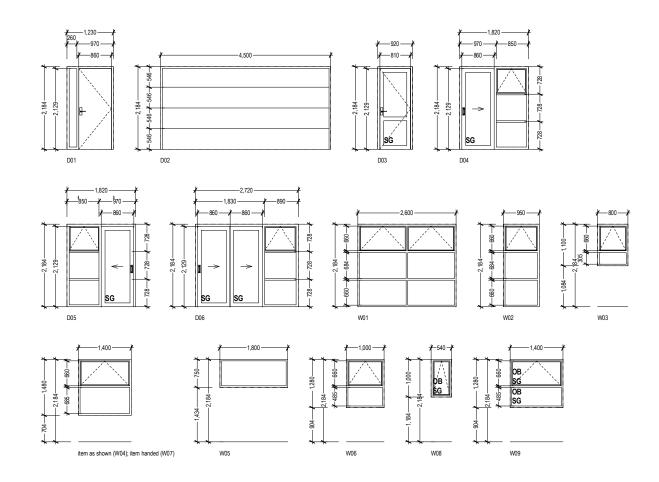

## Door & Window Schedule

SCALE 1:100 @A3

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**Door & Window Schedule** 

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