# pak design ARCHITECTURAL DESIGNERS —

APPROVED
BC210342
17/11/2021
Nigel Moore
Page 1 of 29
Central Hawkes Bay
District Council

8 Connolly Place, Palmerston North P: 06 350 3902 E: office@pakdesign.co.nz www.pakdesign.co.nz

### **DRAWING REGISTER**

PROJECT:Tritt HomeCLIENT:Nathan + Sally-maria TrittPROJECT NUMBER: 20030

ADDRESS: 296 Homewood Road, ADDRESS: DATE: 15/11/2021

Waipawa

			RFI	RFI	RFI		Τ									
Issue		ВС	1	2	3											
Day		16	04	12	15											
Month		09	10	11	11											
Year		21	21	21	21											
Distributio	n List															
Client – N	athan + Sally-maria Tritt	✓		✓	✓											
TA – Cent Cour	ral Hawke's Bay District ncil	1	<b>✓</b>	<b>√</b>	1											
Sheet Number	Sheet Title	Shee	t Revi	sions												
	ARCHITRECTURAL															
L100	Cover Page/Location Plan	RO														
L101	Site Plan	R0		R1	R2											
L102	Floor Finishes Plan	R0														
L103	Setout Plan	R0														
L104	Bracing Layout	R0														
L105	Foundation & Drainage Plan															
L105a	Water Supply Layout Plan		RO													
L105b	Drainage Schematic Plan	RO	RO	R1												
L106	Roof Drainage Plan	RO														
L107	Electrical Layout	R0														



# pak design

ARCHITECTURAL DESIGNERS

APPROVED
BC210342
17/11/2021
Nigel Moore
Page 2 of 29
Central Hawkes Bay
District Council

8 Connolly Place, Palmerston North P: 06 350 3902 E: office@pakdesign.co.nz www.pakdesign.co.nz

						L									
E101	Elevations 1, 2	R0													
E102	Elevations 3, 4	R0													
\$101	Section 1-1	R0													
D101	Window Details 1	R0													
D102	Window Details 2	R0													
D103	Garage Door Details	R0													
D104	Rinnai Recessed Box Details	R0													
D105	Cladding Details 1	R0													
D106	Cladding Details 2	R0													
D107	Foundation Details	R0	R1												
D108	Roof Details 1	R0													
D109	Roof Details 2	R0													
D110	Various Details 1		R0												
C101	Window & Door Schedule 1	R0													
C102	Window & Door Schedule 2	R0													
	FOUNDATIONS														
S001	General Notes – Sheet 1	1													
S002	General Notes – Sheet 2	1													
S700	Structural Details – Sheet 1	1													
-	Architectural Specification	✓													
A3811	Prefabricated Truss Layout & PS1	<b>√</b>													
A3820	NZS 3604 & MiTEK Lumberlok Timber Fixing Reference	<b>√</b>													
A3827	Wall Bracing Documentation	✓													
A4161	Thermakraft Underlays, Foils, DPC, DPM, & Tapes	<b>√</b>													
A4171	James Hardie Rigid Air Barrier	✓													



# pak design

ARCHITECTURAL DESIGNERS

APPROVED
BC210342
17/11/2021
Nigel Moore
Page 3 of 29
Central Hawkes Bay
District Council

8 Connolly Place, Palmerston North P: 06 350 3902 E: office@pakdesign.co.nz www.pakdesign.co.nz

						L		 							
A4221	Abodo Vertical Cladding System	<b>√</b>													
A4231	Timber Weatherboard Cladding	<b>√</b>													
A4239	JH Soffits	✓													
A4273	Hard as Rocks Eldorado Stone Veneer	✓													
A4311	Roofing Industries Profiled Metal Roofing	<b>√</b>													
A4710	H1, G4, & G7 Calculations	✓													
A4711	Pink Batts Insulation	✓													
A5111	JH Villaboard Lining Documentation	<b>√</b>													
A5113	GIB Aqualine Lining Documentation	<b>√</b>													
A6221	Ardex WPM 155 Rapid Documentation	<b>√</b>													
A7126	Rinnai Infinity Gas Water Heater Documentation	<b>√</b>													
A7555	Escea Gas Fire Documentation	<b>√</b>													
Consultant Append. A	LDE Engineering Structural Documentation	<b>✓</b>													
	Rick Hutchinson Septic Information	<b>√</b>													
															<u> </u>
-	Architectural MODW	✓													<u> </u>
-	Structural MODW	✓													<u> </u>
	Additional RFI Information		<b>√</b>												
	Storm-water Consent			<b>√</b>											



PROJECT:

### TRITT HOME

CLIENT:

N. + S. TRITT

Page 4 of 29
Central Hawkes Bay
District Council

**APPROVED** 

BC210342

17/11/2021


**Nigel Moore** 

**ADDRESS:** 

## 296 HOMEWOOD ROAD, WAIPAWA

LEGAL DESCRIPTION:

LOT 1 DP 545747

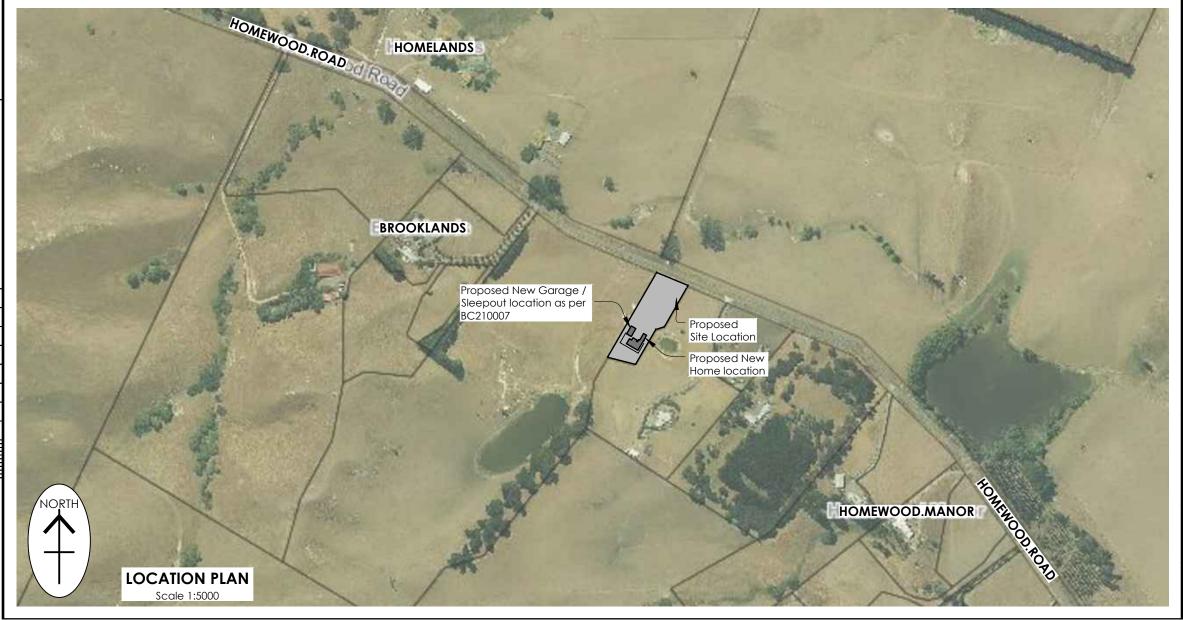

### pak design

ARCHITECTURAL DESIGNERS

Level 1, 328 Church Street, Palmerston North P: 06 350 3902 C:027 204 9423 E:office@pakdesign.co.nz W:www.pakdesign.co.nz COPYRIGHT © ALL RIGHTS RESERVED

#### **CONTENTS:**

L100	Cover Page	R0
L101	Site Plan	R0
L102	Floor Finishes Plan	R0
L103	Setout Plan	RO
L104	Bracing Layout	R0
L105	Foundation & Drainage Plan	R0
L106	Roof Drainage Plan	R0
L107	Electrical Layout	RO
E101	Elevations 1 + 2	RO
E102	Elevations 3 + 4	RO
\$101	Section 1-1, 2-2	RO
D101	Window Details 1	R0
D102	Window Details 2	R0
D103	Garage Door Details	RO
D104	Rinnai Recessed Box Details	R0
D105	Cladding Details 1	R0
D106	Cladding Details 2	R0
D107	Foundation Details	R0
D108	Roofing Details 1	RO
D109	Roofing Details 2	RO
C101	Window & Door Schedule 1	RO
C102	Window & Door Schedule 2	R0
C103	Interior Door Schedule	RO
FOUND	DATIONS	
S001	General Notes - Sheet 1	1


S002 General Notes - Sheet 2S700 Structural Details - Sheet 1


# PROPOSED NEW GARAGE / SLEEPOUT. REFER TO BC210007 FOR DOCUMENTATION


ALL DIMENSIONS TO BE CONFIRMED ON SITE BY CONTRACTOR BEFORE MANUFACTURE / CONSTRUCTION. DO NOT SCALE OFF DRAWINGS. NOTIFY DESIGNER IMMEDIATELY OF ANY DISCREPANCIES. THESE DRAWINGS MUST BE READ IN CONJUNCTION WITH ALL SPECIFICATIONS, ENGINEER & SUB-CONSULTANTS DOCUMENTATION & TRADE RELATED PUBLICATIONS. CONSTRUCT IN ACCORDANCE WITH THE NEW ZEALAND BUILDING CODE & OTHER STATUTORY, REGULATORY DOCUMENTS & TERRITORIAL AUTHORITY REQUIREMENTS.


1 : 500	0		L100		RO
SCALE:		DR	RAWING #:		REV:
ISSUE:	Conse	ent	CHECKED:	MC	CJ
DESIGNED:	MCJ		DRAWN:		)
DATE:	21-Sep	o-21	JOB #:	200	030


8—

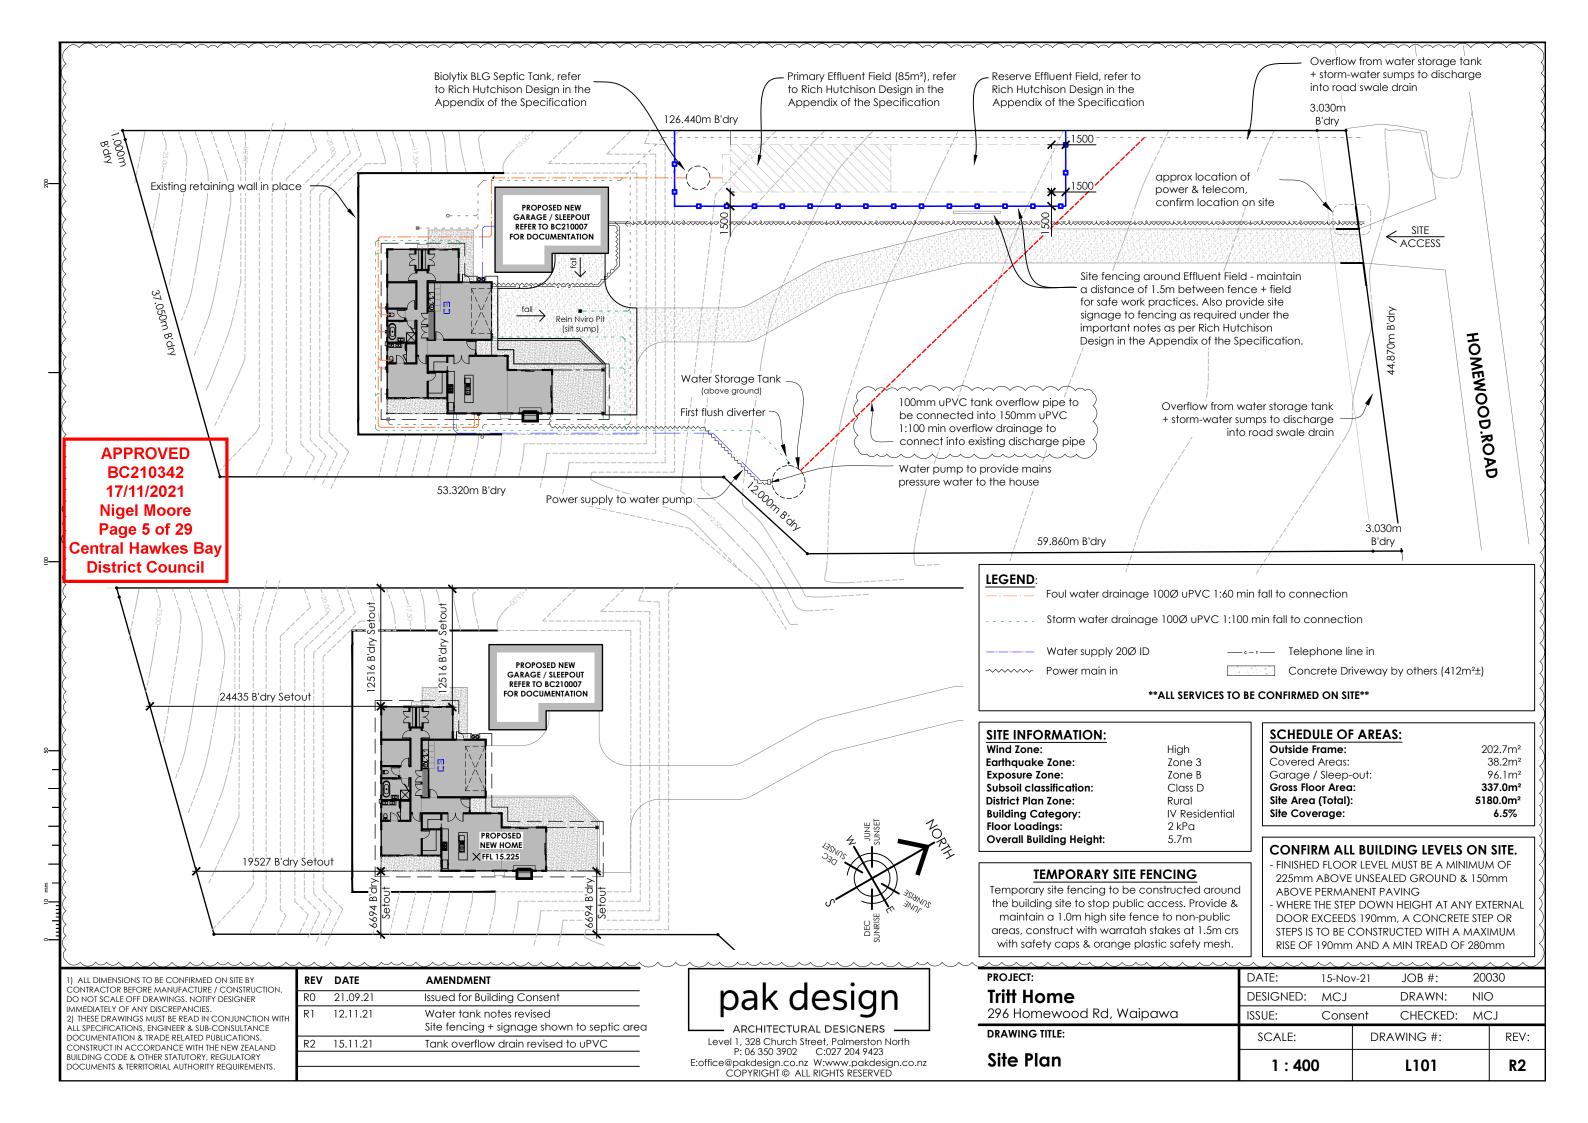


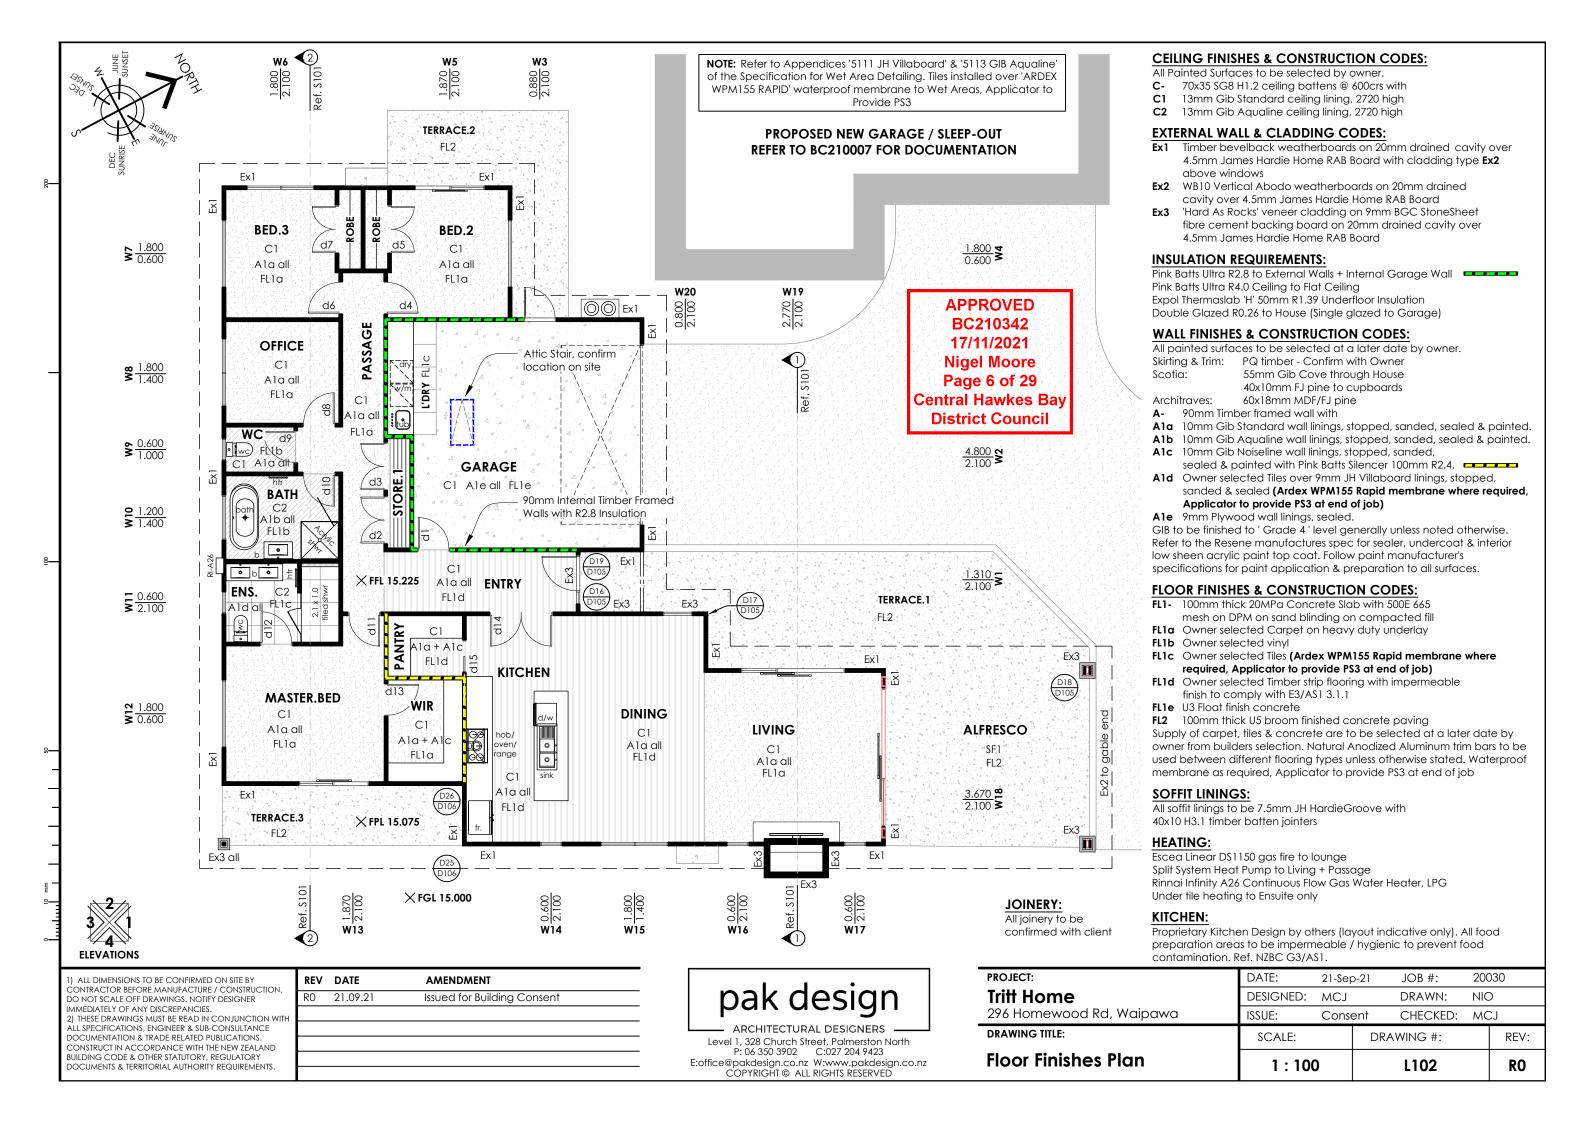

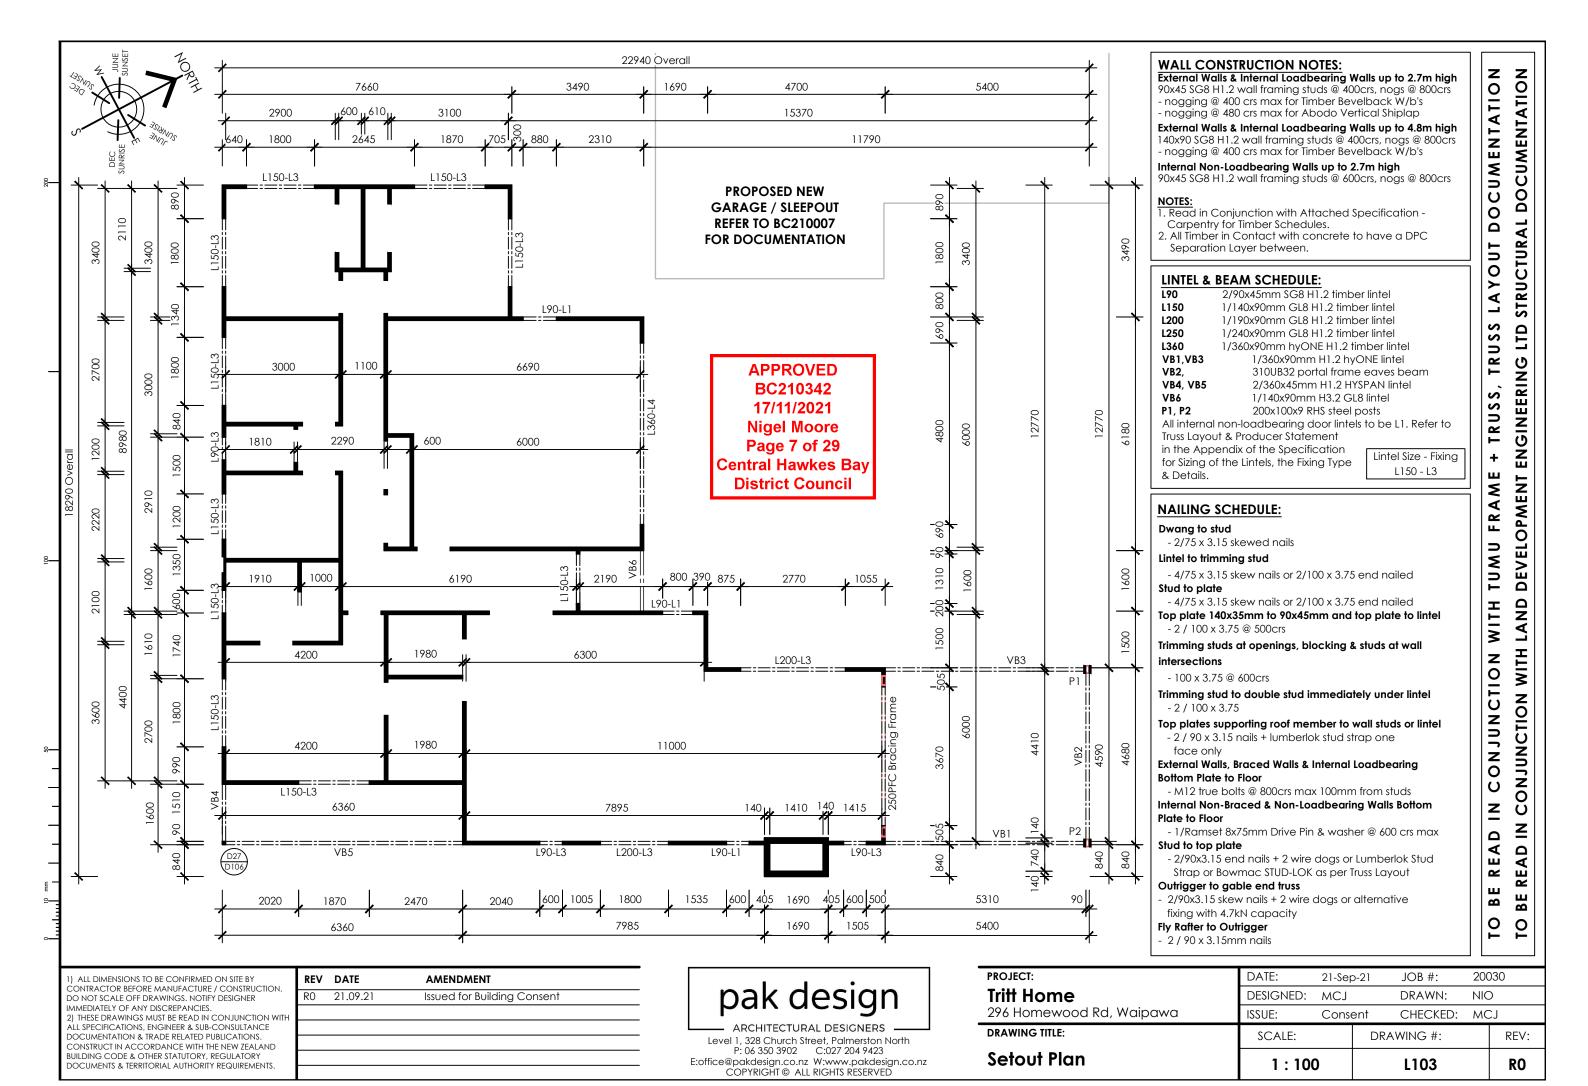

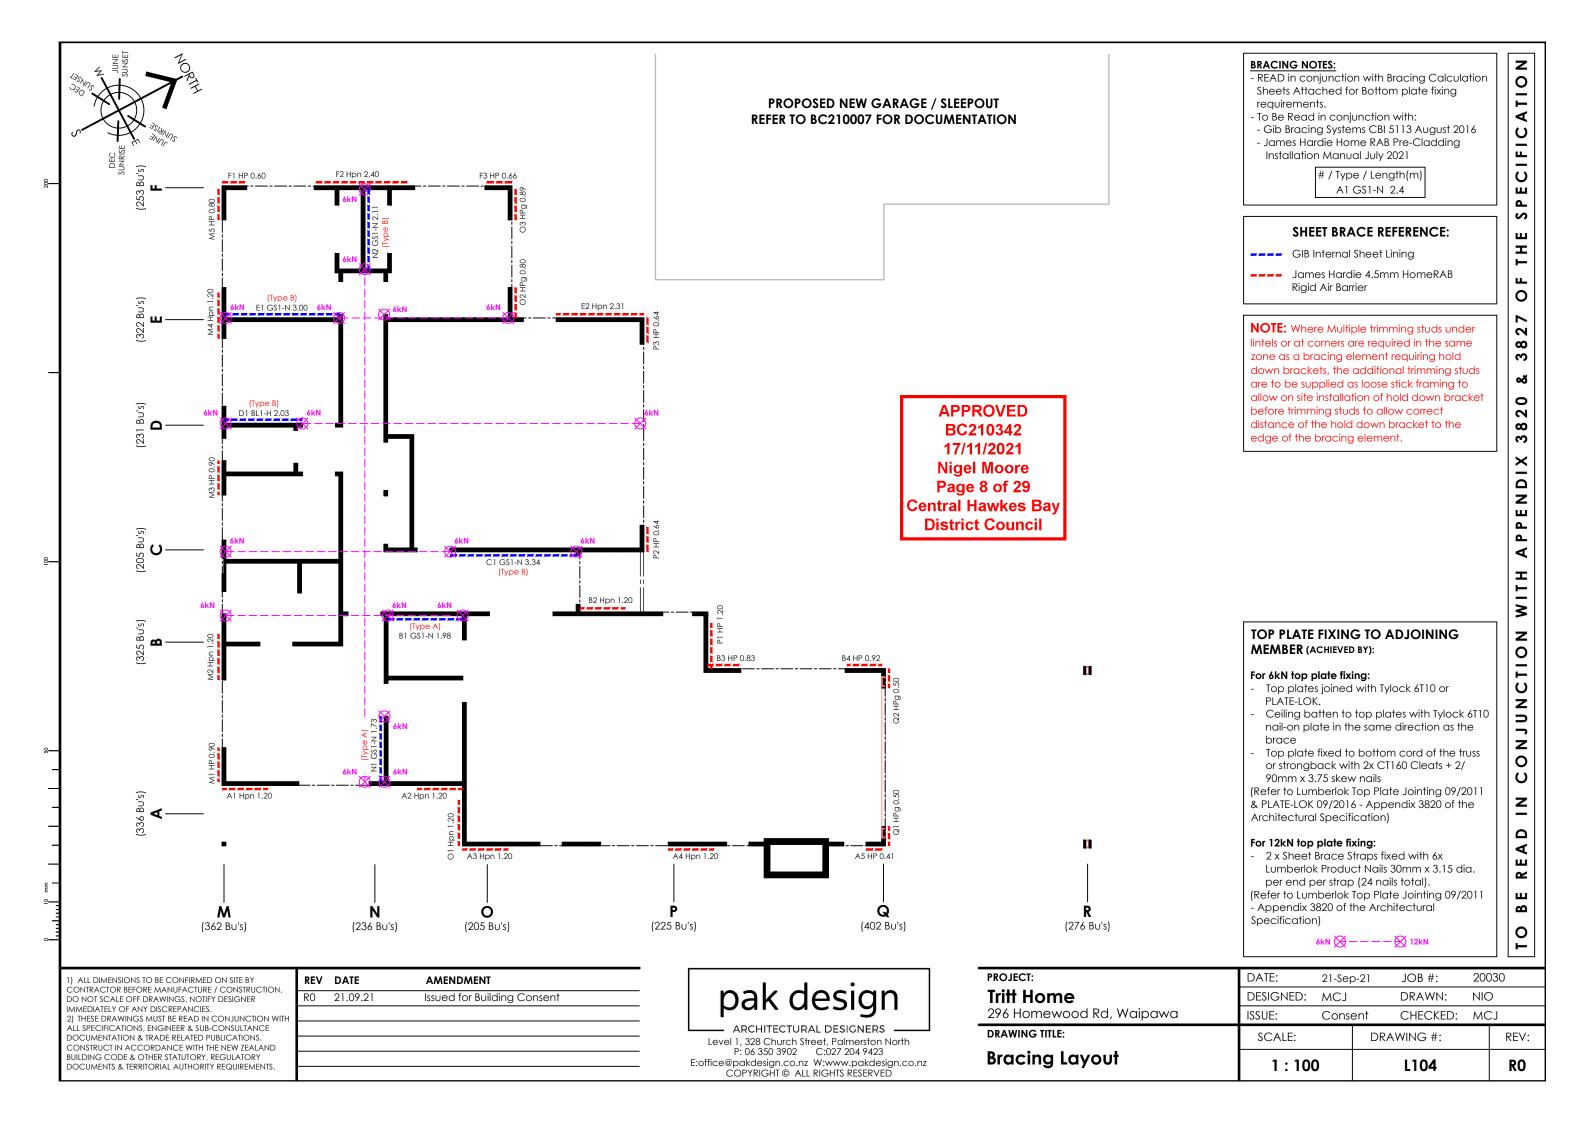

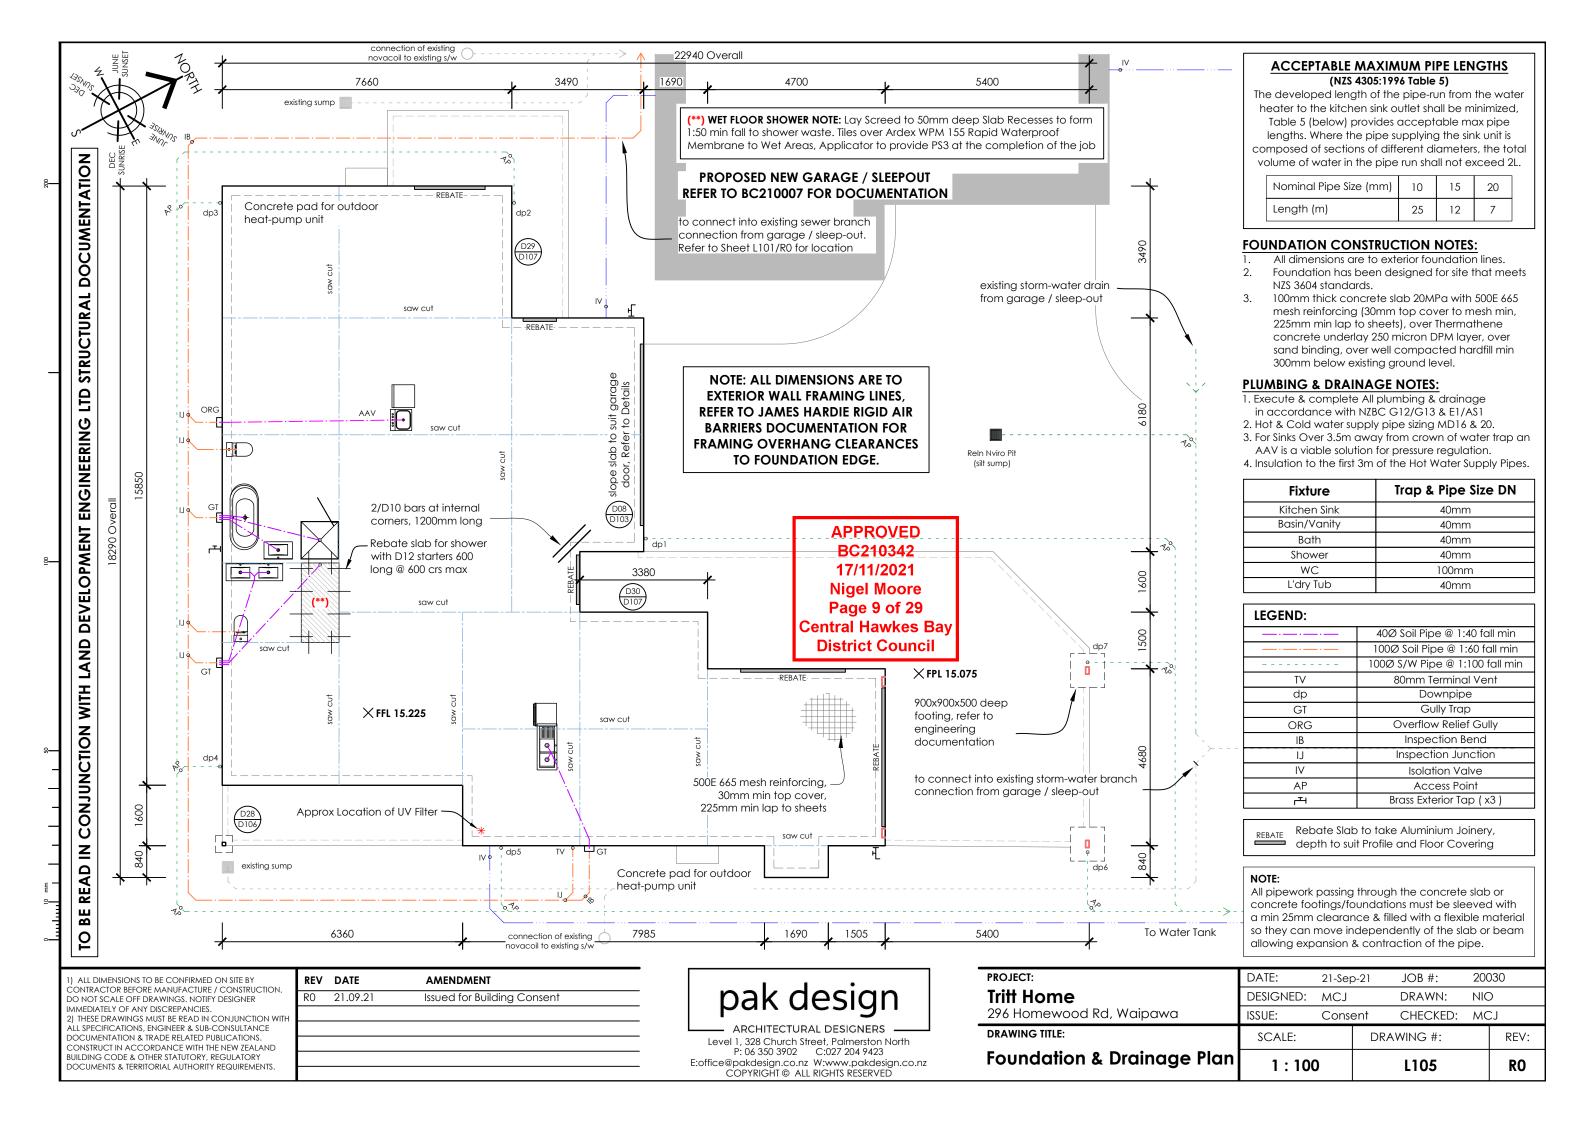

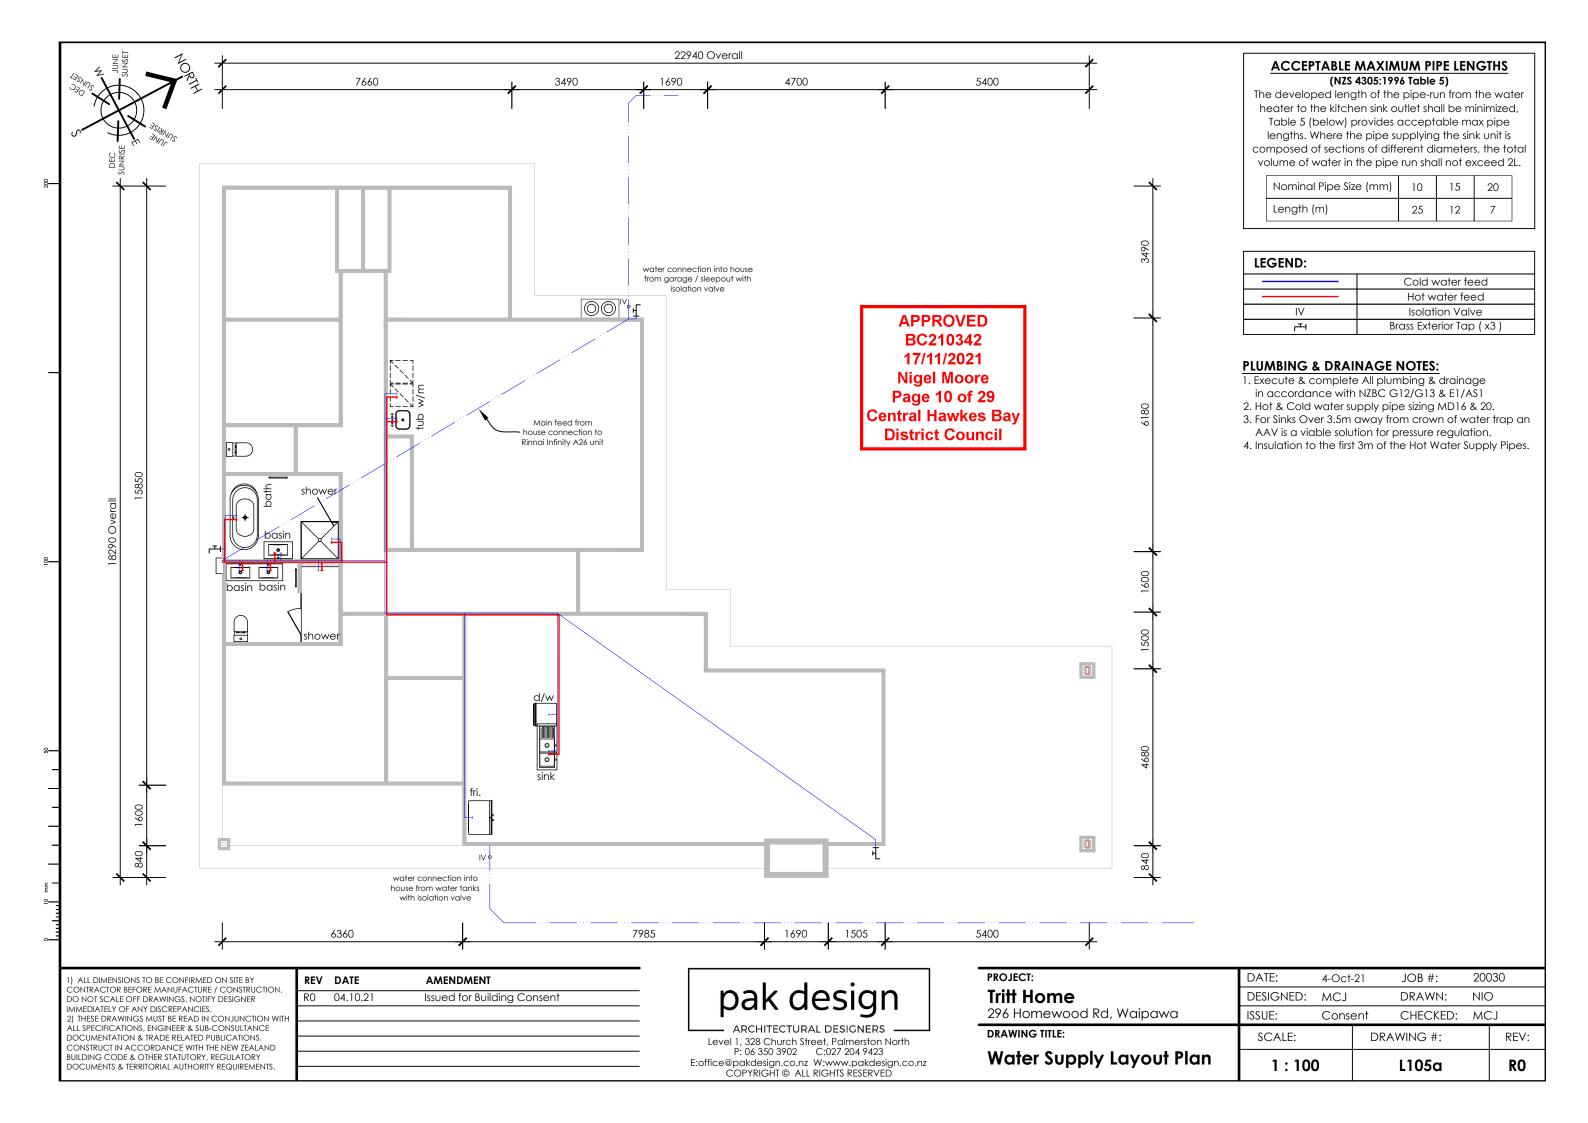

### TO BE READ IN CONJUNCTION WITH L101, L105 + ENGINEERING DOCUMENTATION FOR SLAB + DRAINAGE INFORMATION Bedding and backfilling Paragraphs 3.9.2, 3.9.4 and 3.9.5 Figure 13: Joins sections B-B -FIII (see note 1) 40 1 100Ø Soil Pipe @ 1:60 fall min sewer connection where Compacted selected fill house meets existing sewer branch at garage / sleepout **SECTION A-A** Compacted granular bedding Joins sections A-A Joins sections C-C Width B (a) Cover greater than 500mm 100Ø Soil Pipe @ 1:60 fall min **SECTION B-B** great 75mm 10 0 FIII (see note 1) Joins sections B-B Joins sections D-D Compacted granular bedding and surround Width B 100Ø Soil Pipe @ 1:60 fall min **APPROVED SECTION C-C** (b) Cover greater than 375mm BC210342 17/11/2021 **Nigel Moore** Page 11 of 29 **Central Hawkes Bay**

Joins sections C-C **District Council** 100Ø Soil Pipe @ 1:60 fall min **SECTION D-D** 

**AMENDMENT** 

Issued for Building Consent

Trench construction detail image added

Level 1, 328 Church Street, Palmerston North E:office@pakdesign.co.nz W:www.pakdesign.co.nz COPYRIGHT © ALL RIGHTS RESERVED

PROJECT:	DATE:	12-Nov	<b>v-2</b> 1	JOB #:	200	)30			
Tritt Home	DESIGNED:	MCJ		DRAWN:	NIC	)			
296 Homewood Rd, Waipawa	ISSUE:	Conse	ent	CHECKED:	MC	CJ			
DRAWING TITLE:	SCALE:		DRA	WING #:		REV:			
Drainage Schematic Plan	1 : 100	)		L105b		R1			

Width B

(c) Cover greater than 125mm

-Ordinary fill where drains are located below gardens and open country.
-Compacted selected fill where the drains are located below residential driveways and similar areas subjected to light traffic.

75mm thick concrete

Compacted granular bedding

and surround

1) ALL DIMENSIONS TO BE CONFIRMED ON SITE BY CONTRACTOR BEFORE MANUFACTURE / CONSTRUCTION. DO NOT SCALE OFF DRAWINGS. NOTIFY DESIGNER IMMEDIATELY OF ANY DISCREPANCIES.

2) THESE DRAWINGS MUST BE READ IN CONJUNCTION WIT ALL SPECIFICATIONS, ENGINEER & SUB-CONSULTANCE DOCUMENTATION & TRADE RELATED PUBLICATIONS. CONSTRUCT IN ACCORDANCE WITH THE NEW ZEALAND BUILDING CODE & OTHER STATUTORY, REGULATORY DOCUMENTS & TERRITORIAL AUTHORITY REQUIREMENTS.

**REV DATE** 


R1 12.11.21

R0

04.10.21

pak design

NOTE: 1. Fill shall be:

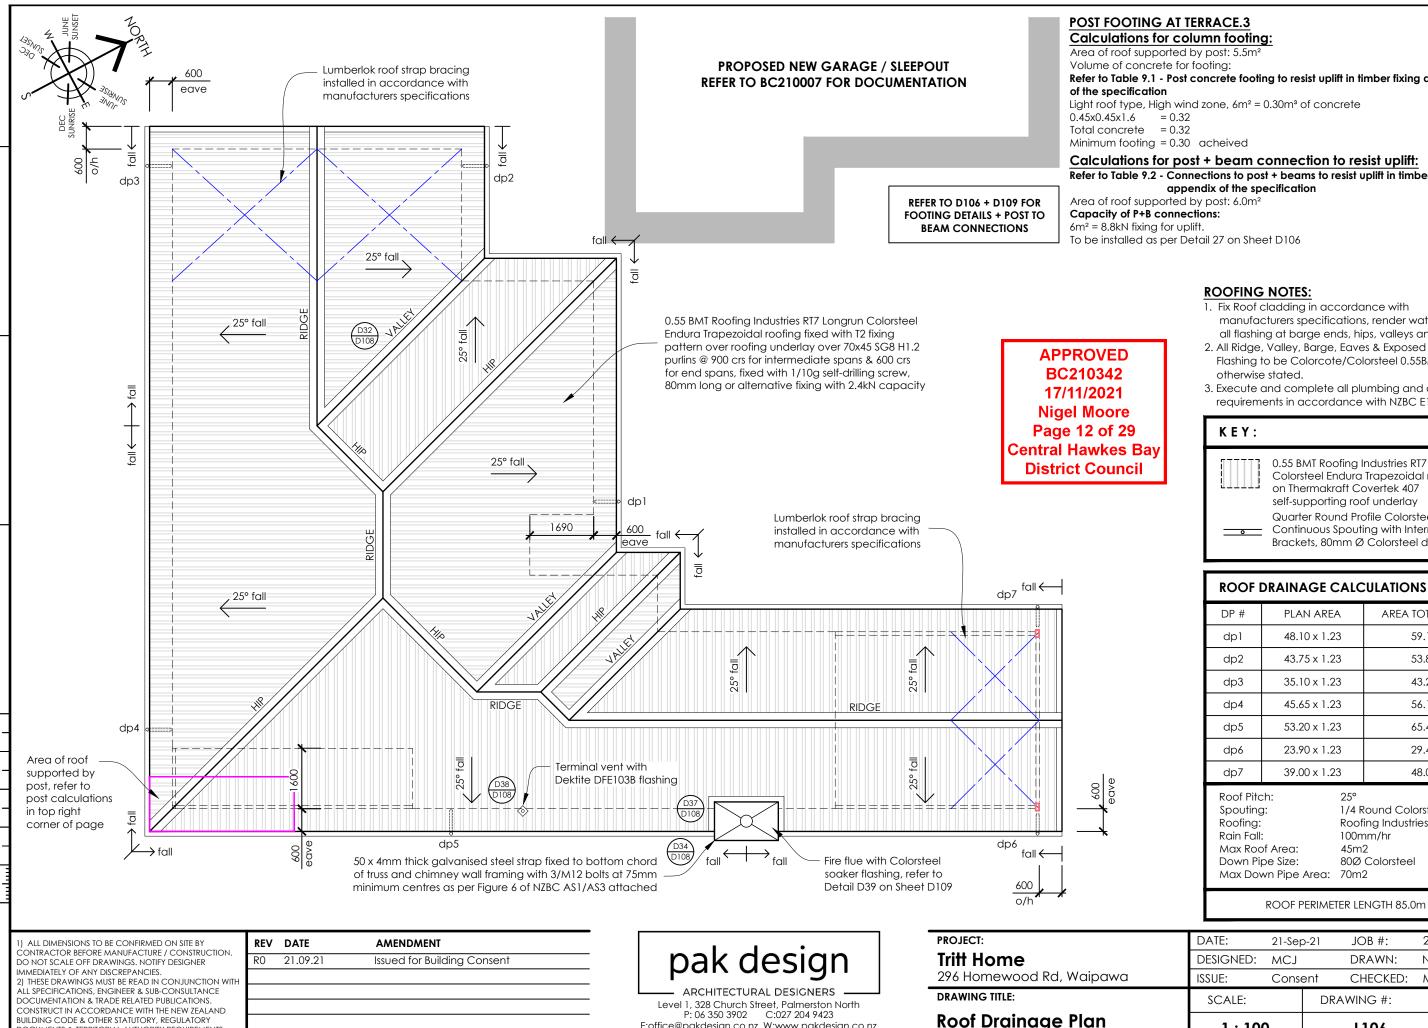

Refer to Table 9.1 - Post concrete footing to resist uplift in timber fixing appendix

Light roof type, High wind zone, 6m<sup>2</sup> = 0.30m<sup>3</sup> of concrete

Calculations for post + beam connection to resist uplift:

Refer to Table 9.2 - Connections to post + beams to resist uplift in timber fixing appendix of the specification

#### **ROOFING NOTES:**

- 1. Fix Roof cladding in accordance with manufacturers specifications, render water-tight all flashing at barge ends, hips, valleys and ridge.
- 2. All Ridge, Valley, Barge, Eaves & Exposed Apron Flashing to be Colorcote/Colorsteel 0.55BMT Unless otherwise stated.
- 3. Execute and complete all plumbing and drainage requirements in accordance with NZBC E1



ı	ROOF	ROOF DRAINAGE CALCULATIONS											
	DP#	PLAN AREA	AREA TOTAL (m²)										
	dpl	48.10 x 1.23	59.15										
	dp2	43.75 x 1.23	53.80										
	dp3	35.10 x 1.23	43.20										
	dp4	45.65 x 1.23	56.15										
	dp5	53.20 x 1.23	65.40										
	dp6	23.90 x 1.23	29.40										
	dp7	39.00 x 1.23	48.00										

Roof Pitch:

1/4 Round Colorsteel Roofing Industries RT7 Roofing: 100mm/hr

Max Roof Area: 45m2 Down Pipe Size: 80Ø Colorsteel Max Down Pipe Area: 70m2

ROOF PERIMETER LENGTH 85.0m ±


CONSTRUCT IN ACCORDANCE WITH THE NEW ZEALAND BUILDING CODE & OTHER STATUTORY, REGULATORY DOCUMENTS & TERRITORIAL AUTHORITY REQUIREMENTS.

REV	DATE	AMENDMENT
R0	21.09.21	Issued for Building Consent

E:office@pakdesign.co.nz W:www.pakdesign.co.nz COPYRIGHT © ALL RIGHTS RESERVED

Roof	<b>Drainage</b>	Pla

DATE:	21-Sep	o-21	JOB #:	200	030
DESIGNED:	MCJ		DRAWN:	NIC	
ISSUE:	Conse	ent	CHECKED:	MC	CJ
SCALE:		DF	RAWING #:		REV:
1:100	)		L106		RO

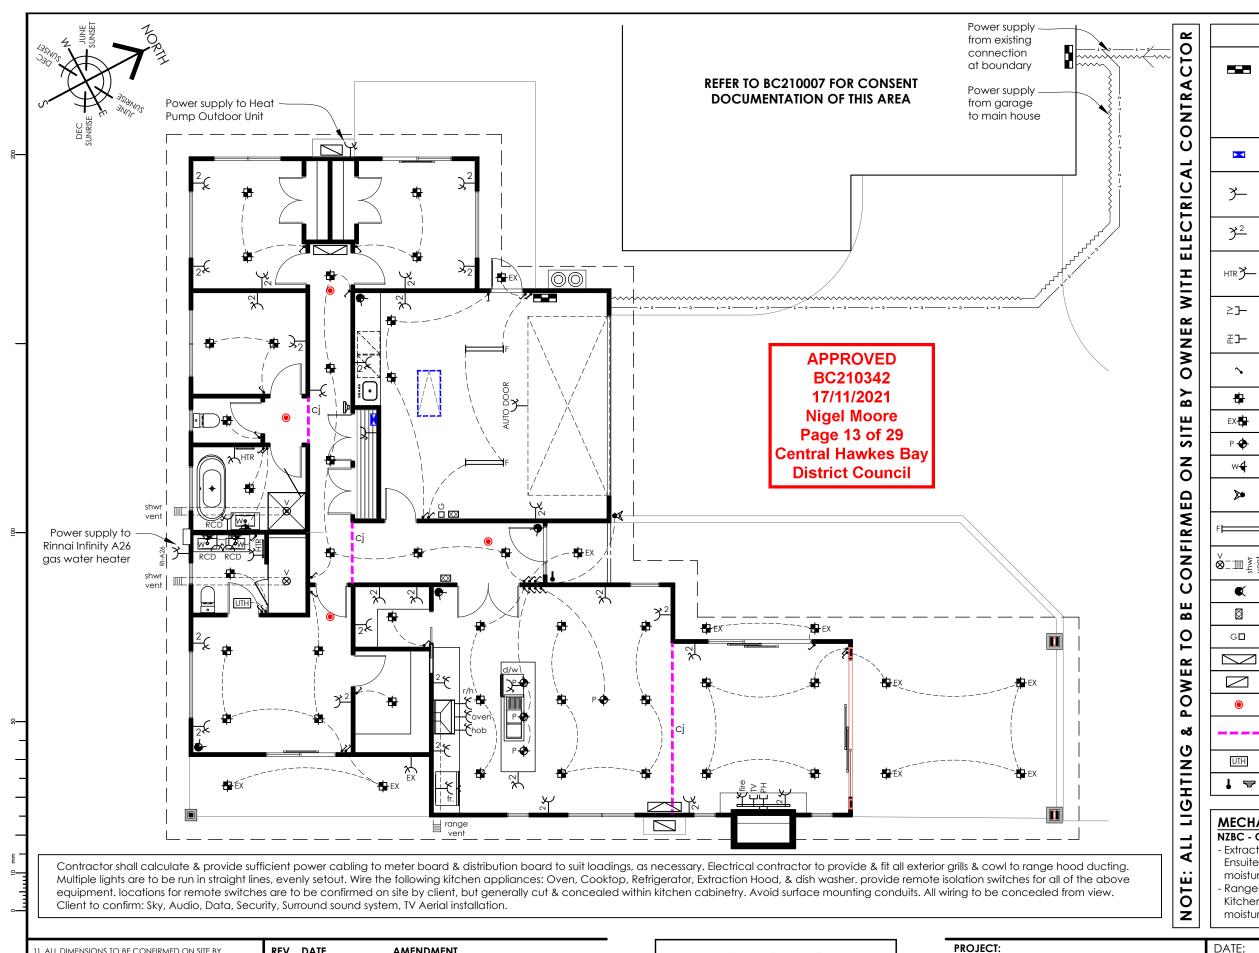

•	Security :	Sensor	· x4			
	Security	contro	ol pad x2 (Entry	+ Gar	age)	
G□	Garage	Door v	vall mounted o	control		
	High wal	l heat	pump x2			
	Heat pur	np ou	tdoor unit x2			
•	Battery C	)pera	ted Smoke Ala	rm		
	GIB Ceilir as per GI	_	ntrol Joint Guide			
UTH	Under Tile	e Heat	ting Element			
1 &	Door Bell	& Ch	ime			
	•					
NZBC - G4 - Extract for Ensuite to moisture - Rangehor Kitchen	A/AS1 - Par ans (Incl. co o provide o generate bood/Extract to provide	ra 1.3.3 ussocia a min d by th at fan a min	CT VENTILAT  3  sted ducting) the flow rate of 25  ne Shower & B (Incl. associated flow rate of 50  ne cooktop.	o Bath L/s to re ath.	emove ting) to	
DATE	21.2	0.1	100 "	000	220	
DATE:	21-Sep 21-Sep	D-21	JOB #:	NIC	030	
	Conse	ont.	CHECKED			
SCALE:			RAWING #:	. 1410	REV:	
JOALL.		Di	<del>(Αννίπο π.</del>		KLV.	
1:1	00		L107		RO	

**ELECTRICAL LEGEND** 

Flush mounted distribution + meter board,

proprietary manufactured, zinc plated

door. Provide board complete with all

Single socket outlet PDL 600 series white cover plate (height determined on site) ("RCD" Denote RCD Type socket)

Double socket outlet PDL 600 series white cover plate (height determined on site) Switched Heated Towel Rail powerpoint

Single socket outlet PDL 600 series white

cover plate (height determined on site)

required circuit breakers & RCD

Fibre/Telephone Demarc Point

with dedicated Power Supply

PDL 600 series white cover plate

(height determined on site)

("TV" Denote TV Aerial Outlet)

white switch, 1000mm high

Wall mounted Exterior Double

with owner selected diffuser

on timer linked to light switch

1500 long double fluorescent fitting

Mechanical vent Extract Fan run

Exterior LED Down Light

LED Down Light

Pendant light

Wall Mounted light

Spot Light with Sensor

("PH" Denote Phone / Data Outlet)

PDL 600 series white cover plate,

protection to all necessary circuits.

powder coated metal case with hinged

1) ALL DIMENSIONS TO BE CONFIRMED ON SITE BY CONTRACTOR BEFORE MANUFACTURE / CONSTRUCTION DO NOT SCALE OFF DRAWINGS. NOTIFY DESIGNER

IMMEDIATELY OF ANY DISCREPANCIES 2) THESE DRAWINGS MUST BE READ IN CONJUNCTION WITH ALL SPECIFICATIONS, ENGINEER & SUB-CONSULTANCE DOCUMENTATION & TRADE RELATED PUBLICATIONS. CONSTRUCT IN ACCORDANCE WITH THE NEW ZEALAND BUILDING CODE & OTHER STATUTORY, REGULATORY DOCUMENTS & TERRITORIAL AUTHORITY REQUIREMENTS.

REV	DATE	AMENDMENT
R0	21.09.21	Issued for Building Consent


## pak design


Level 1, 328 Church Street, Palmerston North E:office@pakdesign.co.nz W:www.pakdesign.co.nz COPYRIGHT @ ALL RIGHTS RESERVED


Tritt Home	
296 Homewood Rd, Waipawa	


DRAWING TITLE:


**Electrical Layout** 

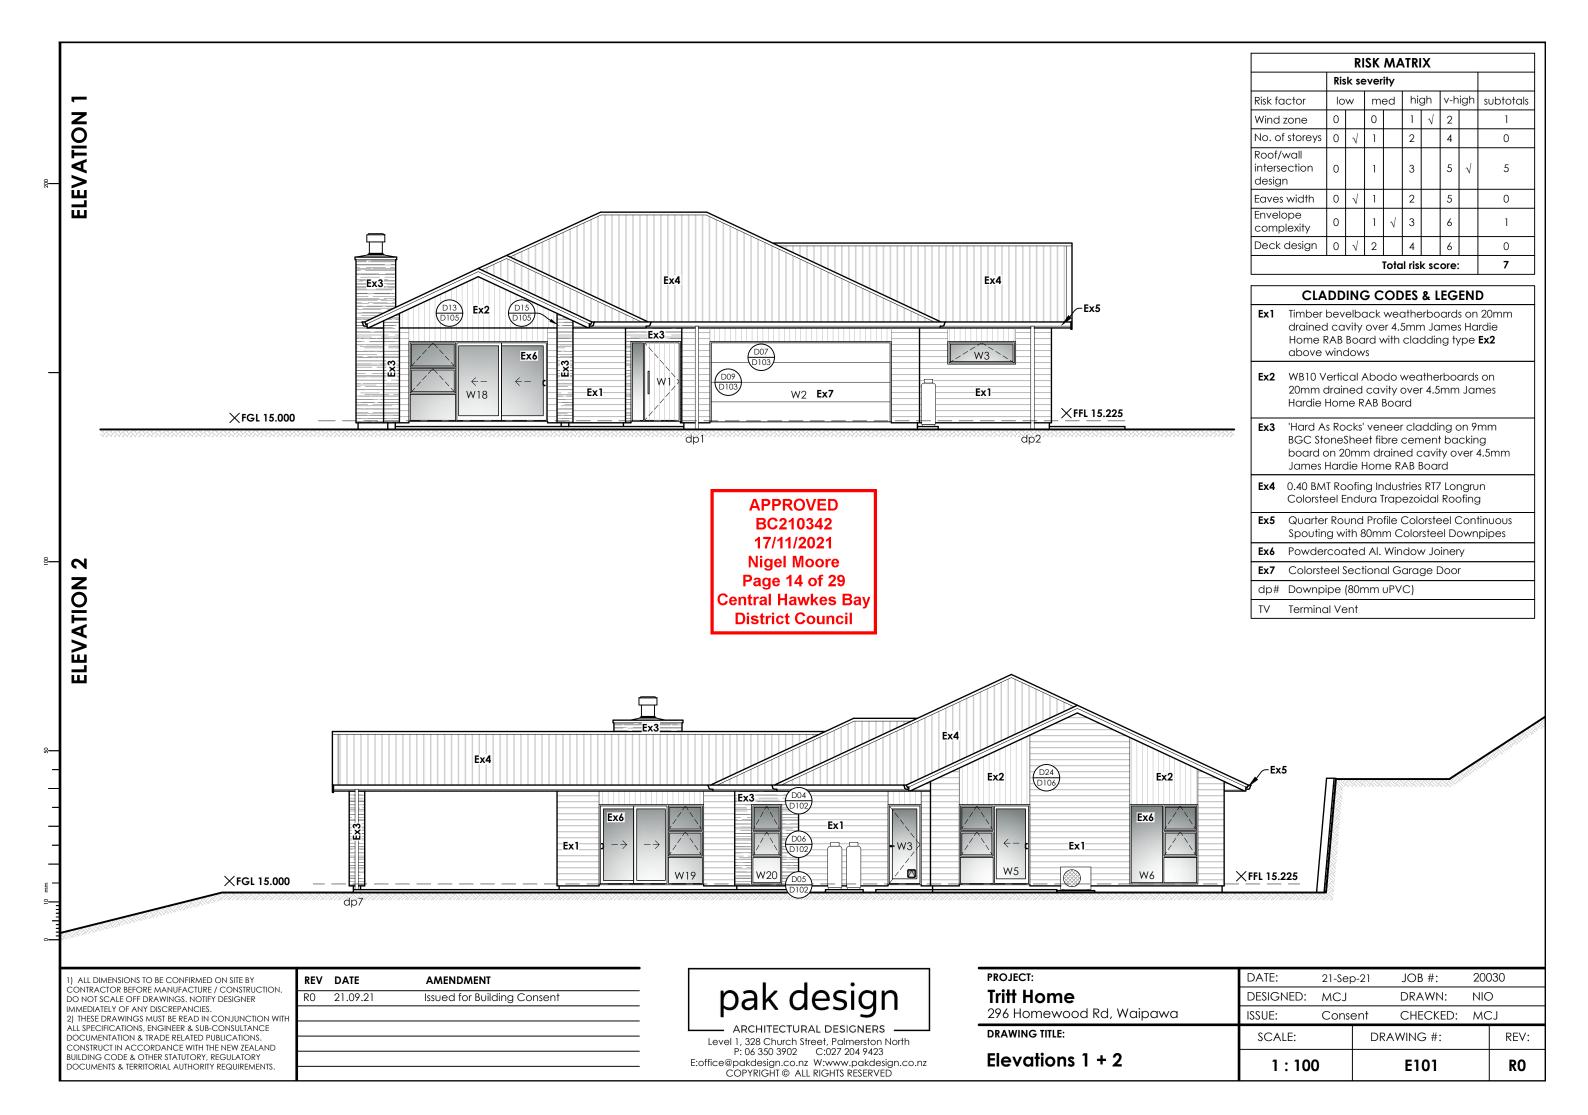

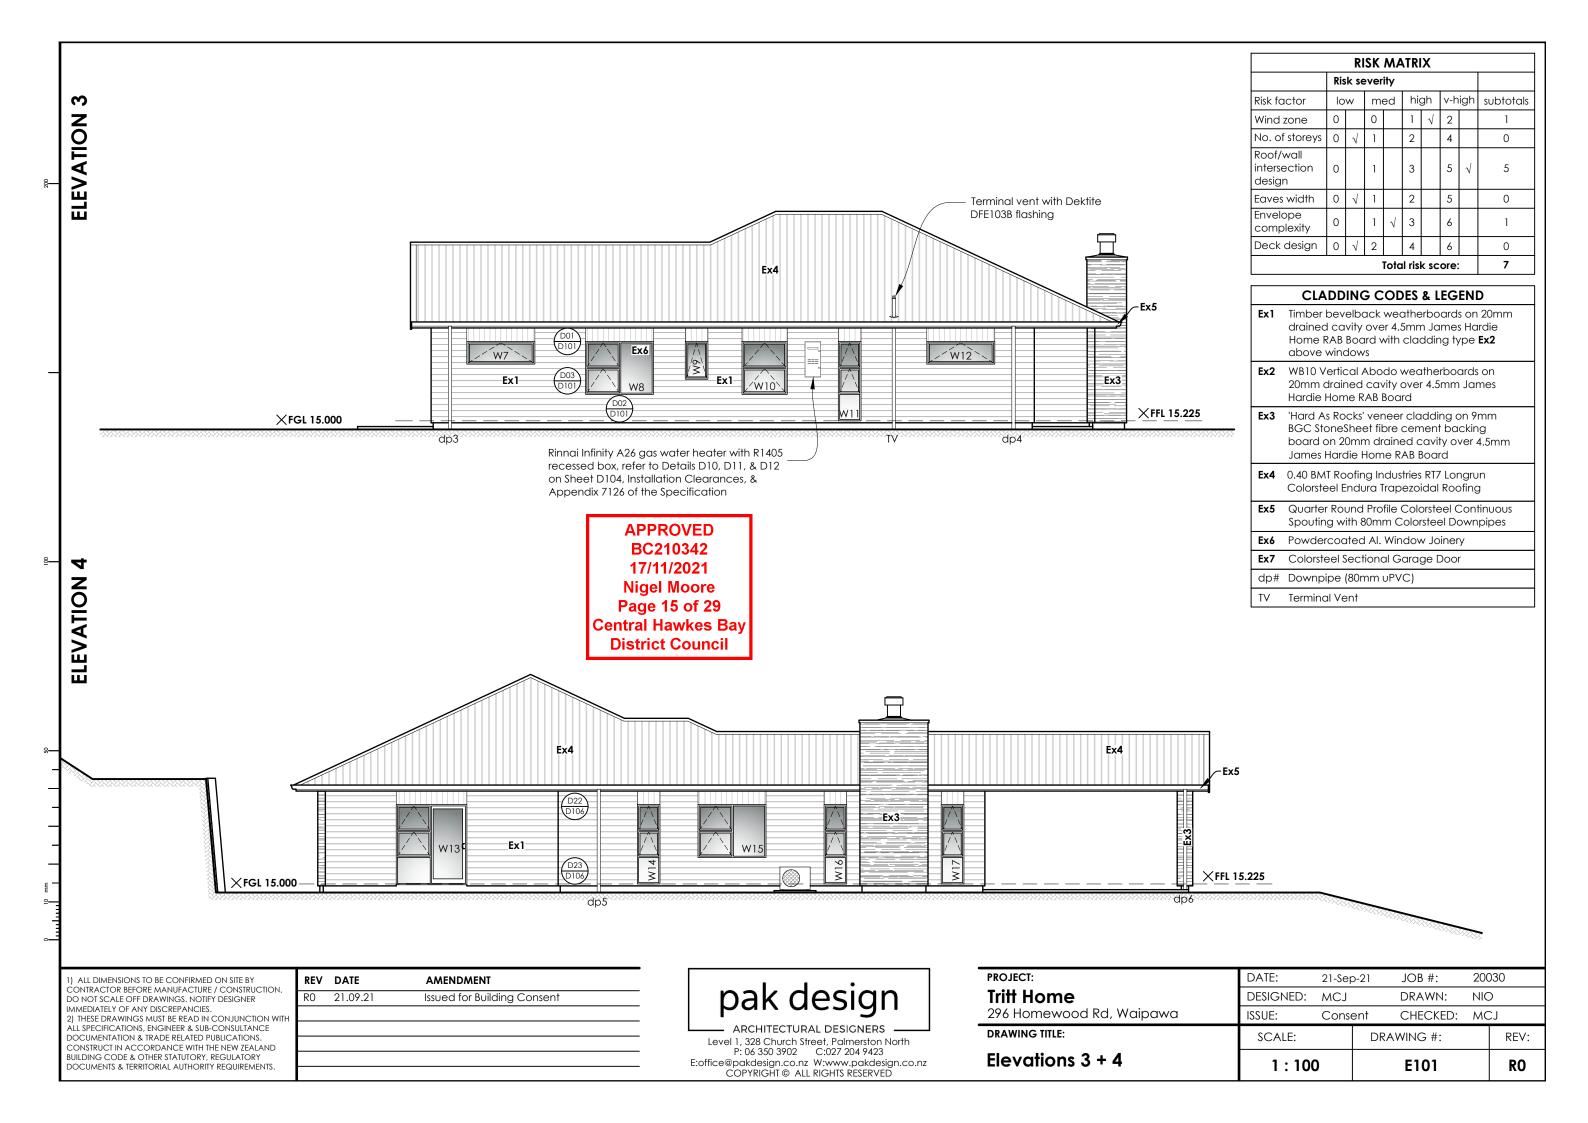

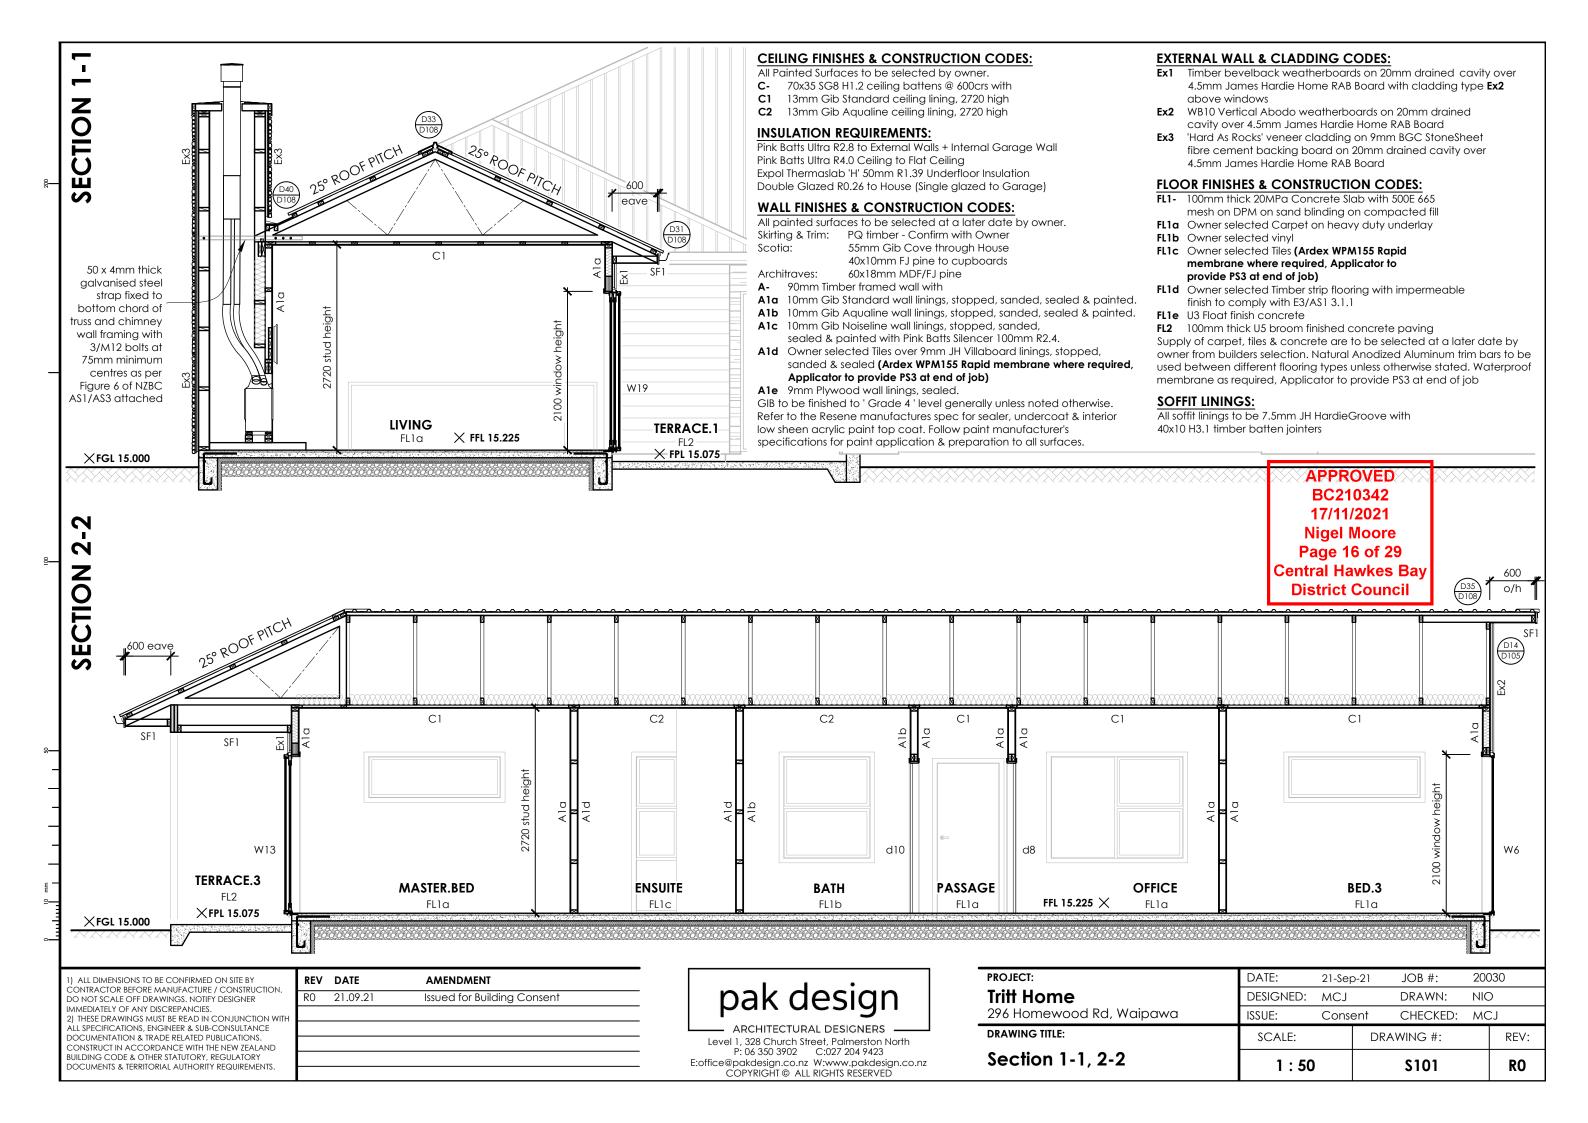

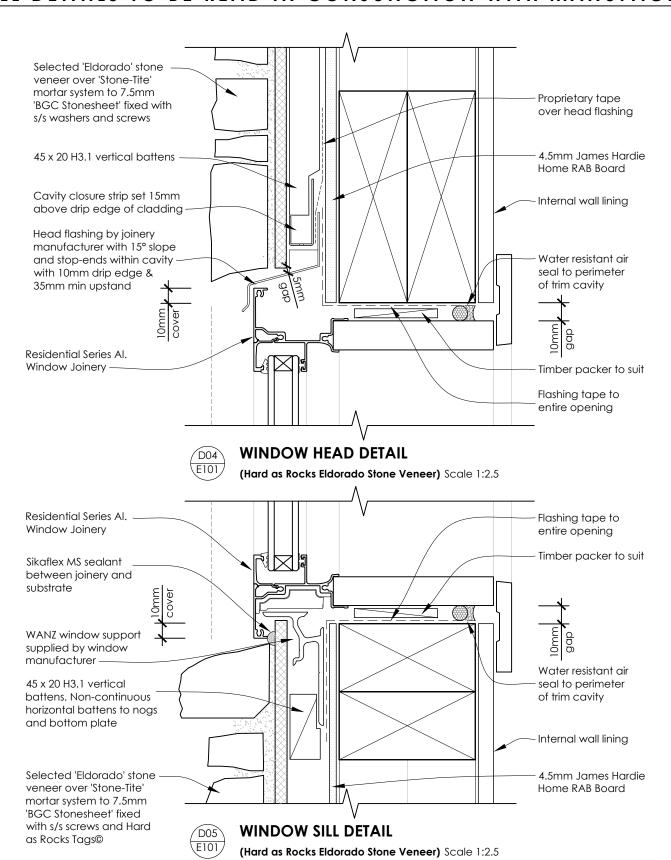

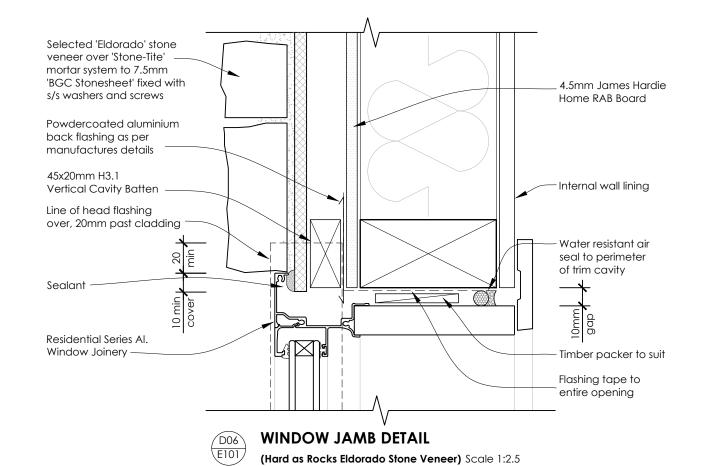

APPROVED
BC210342
17/11/2021
Nigel Moore
Page 17 of 29
Central Hawkes Bay
District Council

1) ALL DIMENSIONS TO BE CONFIRMED ON SITE BY CONTRACTOR BEFORE MANUFACTURE / CONSTRUCTION DO NOT SCALE OFF DRAWINGS, NOTIFY DESIGNER IMMEDIATELY OF ANY DISCREPANCIES.
2) THESE DRAWINGS MUST BE READ IN CONJUNCTION WI


IMMEDIATELY OF ANY DISCREPANCIES.


2) THESE DRAWINGS MUST BE READ IN CONJUNCTION WITH ALL SPECIFICATIONS, ENGINEER & SUB-CONSULTANCE DOCUMENTATION & TRADE RELATED PUBLICATIONS. CONSTRUCT IN ACCORDANCE WITH THE NEW ZEALAND BUILDING CODE & OTHER STATUTORY, REGULATORY DOCUMENTS & TERRITORIAL AUTHORITY REQUIREMENTS.

REV	DATE	AMENDMENT
R0	21.09.21	Issued for Building Consent

pak design

PROJECT: Tritt Home	DATE: DESIGNED:	21-Sep MCJ	DRAWN:	200 NIC	
296 Homewood Rd, Waipawa	ISSUE:	Conse		MC	-
DRAWING TITLE: Window Details 1	SCALE:		DRAWING #:		REV:
-Eldorado Stone Veneer	1:2.5		D101		RO

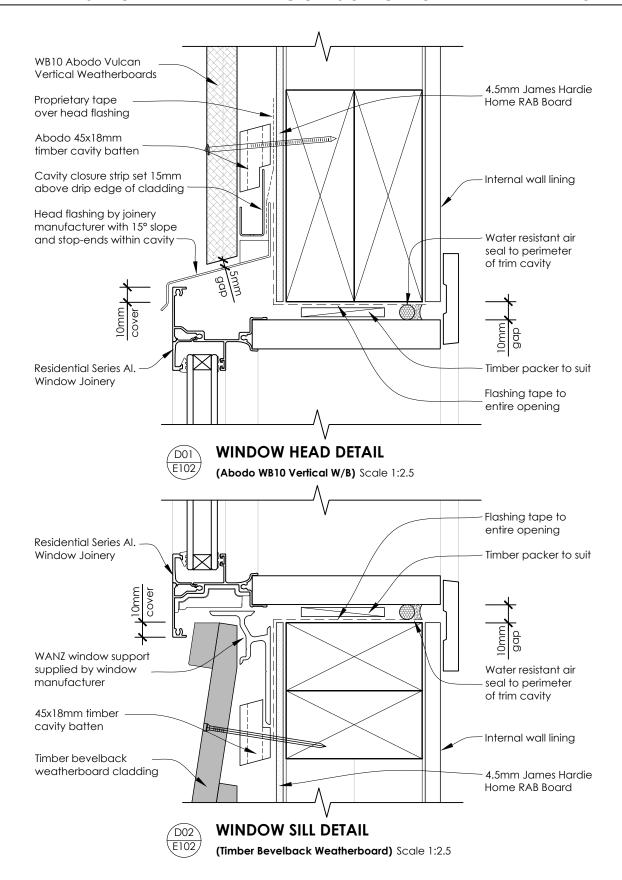

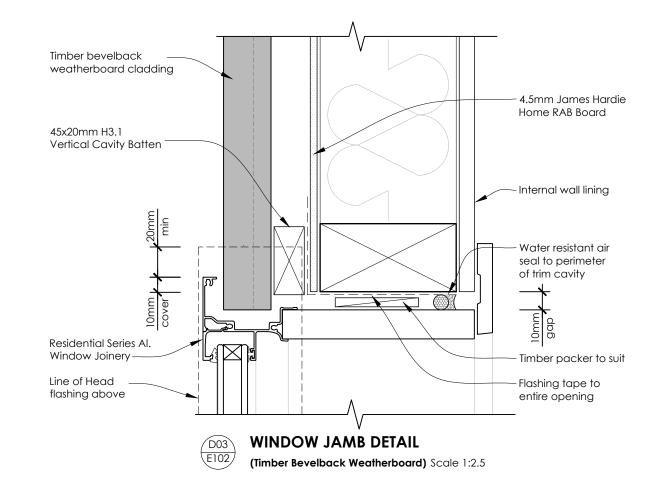

APPROVED
BC210342
17/11/2021
Nigel Moore
Page 18 of 29
Central Hawkes Bay
District Council

ALL DIMENSIONS TO BE CONFIRMED ON SITE BY
CONTRACTOR BEFORE MANUFACTURE / CONSTRUCTION
DO NOT SCALE OFF DRAWINGS. NOTIFY DESIGNER
IMMEDIATELY OF ANY DISCREPANCIES.
2) THESE DRAWINGS MUST BE READ IN CONJUNCTION WI

IMMEDIATELY OF ANY DISCREPANCIES.


2) THESE DRAWINGS MUST BE READ IN CONJUNCTION WITH ALL SPECIFICATIONS, ENGINEER & SUB-CONSULTANCE DOCUMENTATION & TRADE RELATED PUBLICATIONS.

CONSTRUCT IN ACCORDANCE WITH THE NEW ZEALAND BUILDING CODE & OTHER STATUTORY, REGULATORY DOCUMENTS & TERRITORIAL AUTHORITY REQUIREMENTS.


REV	DATE	AMENDMENT
R0	21.09.21	Issued for Building Consent


pak design

PROJECT:	DATE:	21-Sep	-21 JOB #:	200	)30
Tritt Home	DESIGNED:	MCJ	DRAWN:	NIC	)
296 Homewood Rd, Waipawa	ISSUE:	Conse	ent CHECKED:	MC	J
DRAWING TITLE: Window Details 2	SCALE:		DRAWING #:		REV:
-Timber Bevelback W/B's	1:2.5		D102		RO

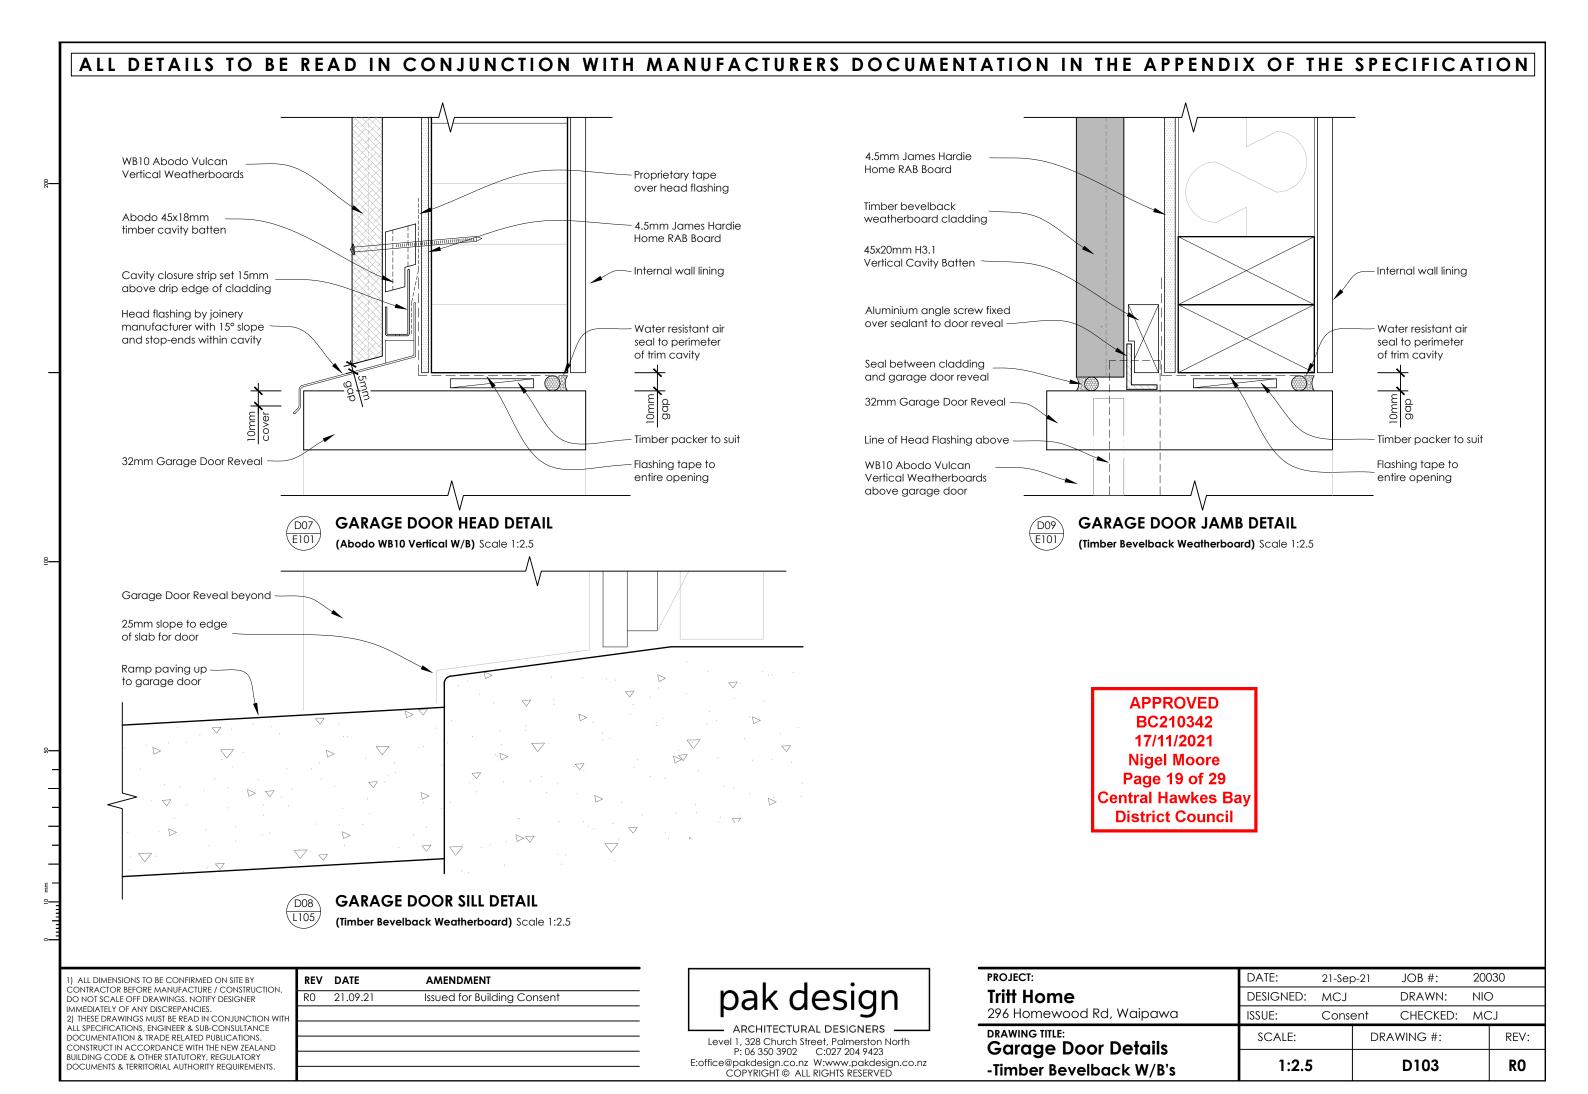

#### ALL DETAILS TO BE READ IN CONJUNCTION WITH MANUFACTURERS DOCUMENTATION IN THE APPENDIX OF THE SPECIFICATION 4.5mm James Hardie 45x20mm H3.1 Home RAB Board Vertical Cavity Batten 45x20mm H3.1 Vertical Proprietary tape 4.5mm James Hardie Timber bevelback over head flashing Cavity Batten Home RAB Board weatherboard cladding Internal wall lining Timber bevelback Internal wall lining weatherboard claddina Timber packer to suit

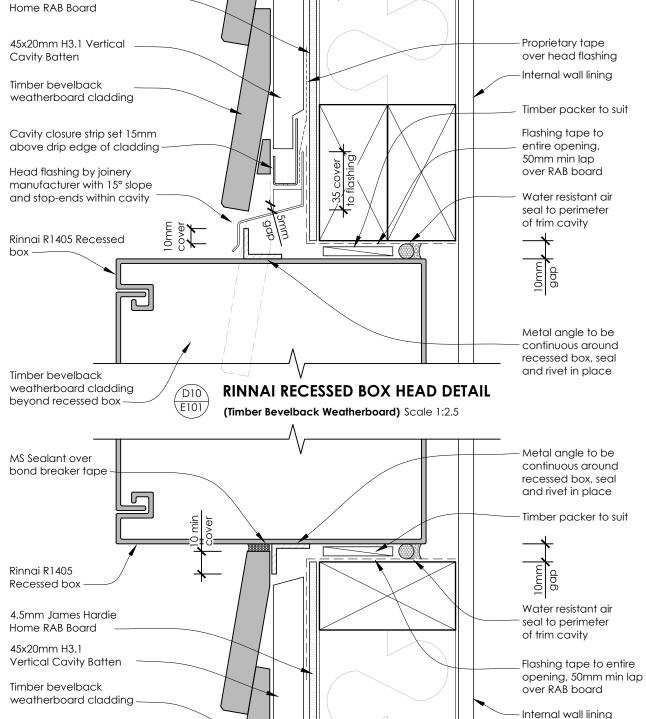

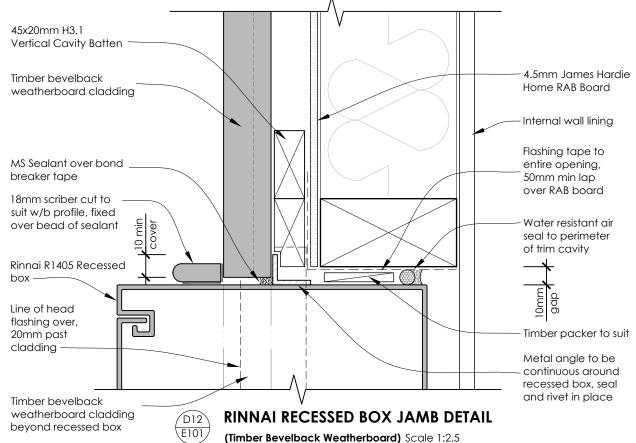



	Description	INFINITY A-Series, HD200, EF24, EF26
ď	Horizontally from an openable door	300 mm
m	Horizontally from an openable window	300 mm
(1	Vertically below an openable window	1500 mm
0	Horizontally from any building structure or obstruction facing the terminal	500 mm
111	From a return wall	300 mm
	From the ground	300 mm*
co	From an external corner	300 mm

ı	1) ALL DIMENSIONS TO BE CONFIRMED ON SITE BY
ı	ONTRACTOR BEFORE MANUFACTURE / CONSTRUCTION
ı	DO NOT SCALE OFF DRAWINGS. NOTIFY DESIGNER
	IMMEDIATELY OF ANY DISCREPANCIES.
ı	2) THESE DRAWINGS MUST BE READ IN CONJUNCTION

/DII

IMMEDIATELY OF ANY DISCREPANCIES.

2) THESE DRAWINGS MUST BE READ IN CONJUNCTION W
ALL SPECIFICATIONS, ENGINEER & SUB-CONSULTANCE
DOCUMENTATION & TRADE RELATED PUBLICATIONS.
CONSTRUCT IN ACCORDANCE WITH THE NEW ZEALAND
BUILDING CODE & OTHER STATUTORY, REGULATORY
DOCUMENTS & TERRITORIAL AUTHORITY REQUIREMENTS.


	REV	DATE	AMENDMENT
	R0	21.09.21	Issued for Building Consent
+			

RINNAI RECESSED BOX SILL DETAIL


(Timber Bevelback Weatherboard) Scale 1:2.5


pak design

-Timber Bevelback W/B's	1:2.5			D104		RO
DRAWING TITLE: Rinnai Recessed Box Details	SCALE:		DRAWING #:			REV:
296 Homewood Rd, Waipawa	ISSUE:	Conse	ent	CHECKED:	MC	CJ
Tritt Home	DESIGNED:	MCJ		DRAWN:	NIC	)
PROJECT:	DATE:	21-Sep	o-21	JOB #:	200	030

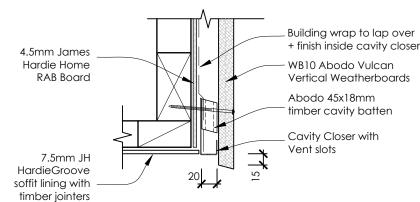

#### **SOFFIT DRIP EDGE DETAIL** (Abodo WB10 Vertical W/B) Scale 1:5

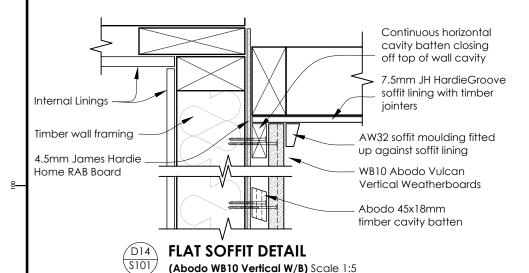


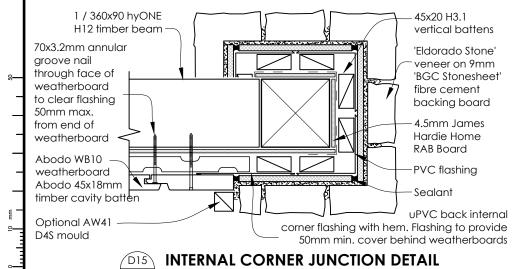


(Abodo WB10 Vertical W/B - Eldorado Stone Veneer) Scale 1:5


I) ALL DIMENSIONS TO BE CONFIRMED ON SITE BY CONTRACTOR BEFORE MANUFACTURE / CONSTRUCTION DO NOT SCALE OFF DRAWINGS. NOTIFY DESIGNER IMMEDIATELY OF ANY DISCREPANCIES 2) THESE DRAWINGS MUST BE READ IN CONJUNCTION WIT

ALL SPECIFICATIONS, ENGINEER & SUB-CONSULTANCE DOCUMENTATION & TRADE RELATED PUBLICATIONS. CONSTRUCT IN ACCORDANCE WITH THE NEW ZEALAND BUILDING CODE & OTHER STATUTORY, REGULATORY DOCUMENTS & TERRITORIAL AUTHORITY REQUIREMENTS.

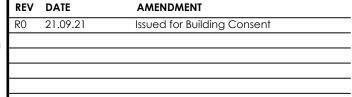


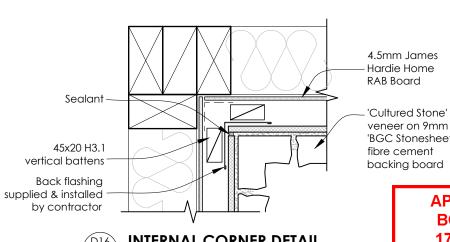

INTERNAL CORNER DETAIL (Hard as Rocks Eldorado Stone Veneer) Scale 1:5

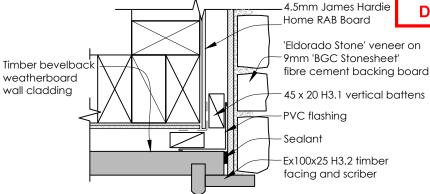

#### **EXTERNAL CORNER JUNCTION DETAIL** (Timber Bevelback W/B - Eldorado Stone Veneer) Scale 1:5

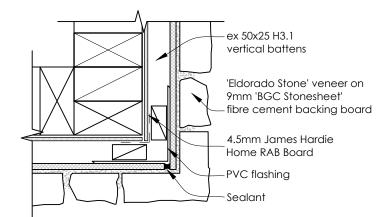

**EXTERNAL CORNER DETAIL** (Hard as Rocks Eldorado Stone Veneer) Scale 1:5

## 'BGC Stonesheet **APPROVED** BC210342 17/11/2021 Nigel Moore Page 21 of 29 Central Hawkes Bay **District Council**


45x20 H3 1 vertical battens 4.5mm James Sealant between Hardie Home fibre cement **RAB Board** backing board + weatherboards 'Cultured Stone' veneer on 9mm Back flashing 'BGC Stonesheet' supplied & installed fibre cement by contractor backing board Timber bevelback weatherboard wall cladding INTERNAL CORNER JUNCTION DETAIL

(Timber Bevelback W/B - Eldorado Stone Veneer) Scale 1:5

Sealant between soffit lining + fibre cement backing board 7.5mm JH HardieGroove soffit lining with timber jointers Internal Linings Timber wall framing 'Eldorado Stone' veneer on 9mm 'BGC Stonesheet' fibre 4.5mm James Hardie cement backing board Home RAB Board 45x20 H3.1 vertical battens

**SOFFIT DETAIL** 

(Hard as Rocks Eldorado Stone Veneer) Scale 1:5

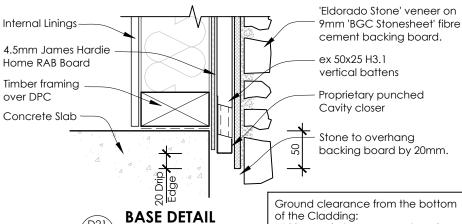


(Hard as Rocks Eldorado **Stone Veneer)** Scale 1:5 of the Cladding:

100mm min to permanent paving 175mm min to unprotected ground


## pak design


Level 1, 328 Church Street, Palmerston North E:office@pakdesign.co.nz W:www.pakdesign.co.nz COPYRIGHT @ ALL RIGHTS RESERVED

Tritt Home 296 Homewood Rd, Waipawa  DRAWING TITLE: Classific at Details 1	DESIGNED: ISSUE: SCALE:	MCJ Conse	DRAWN: CHECKED: WING #:	MC	
Cladding Details 1 -Eldorado Stone Veneer	1:5		D105		RO

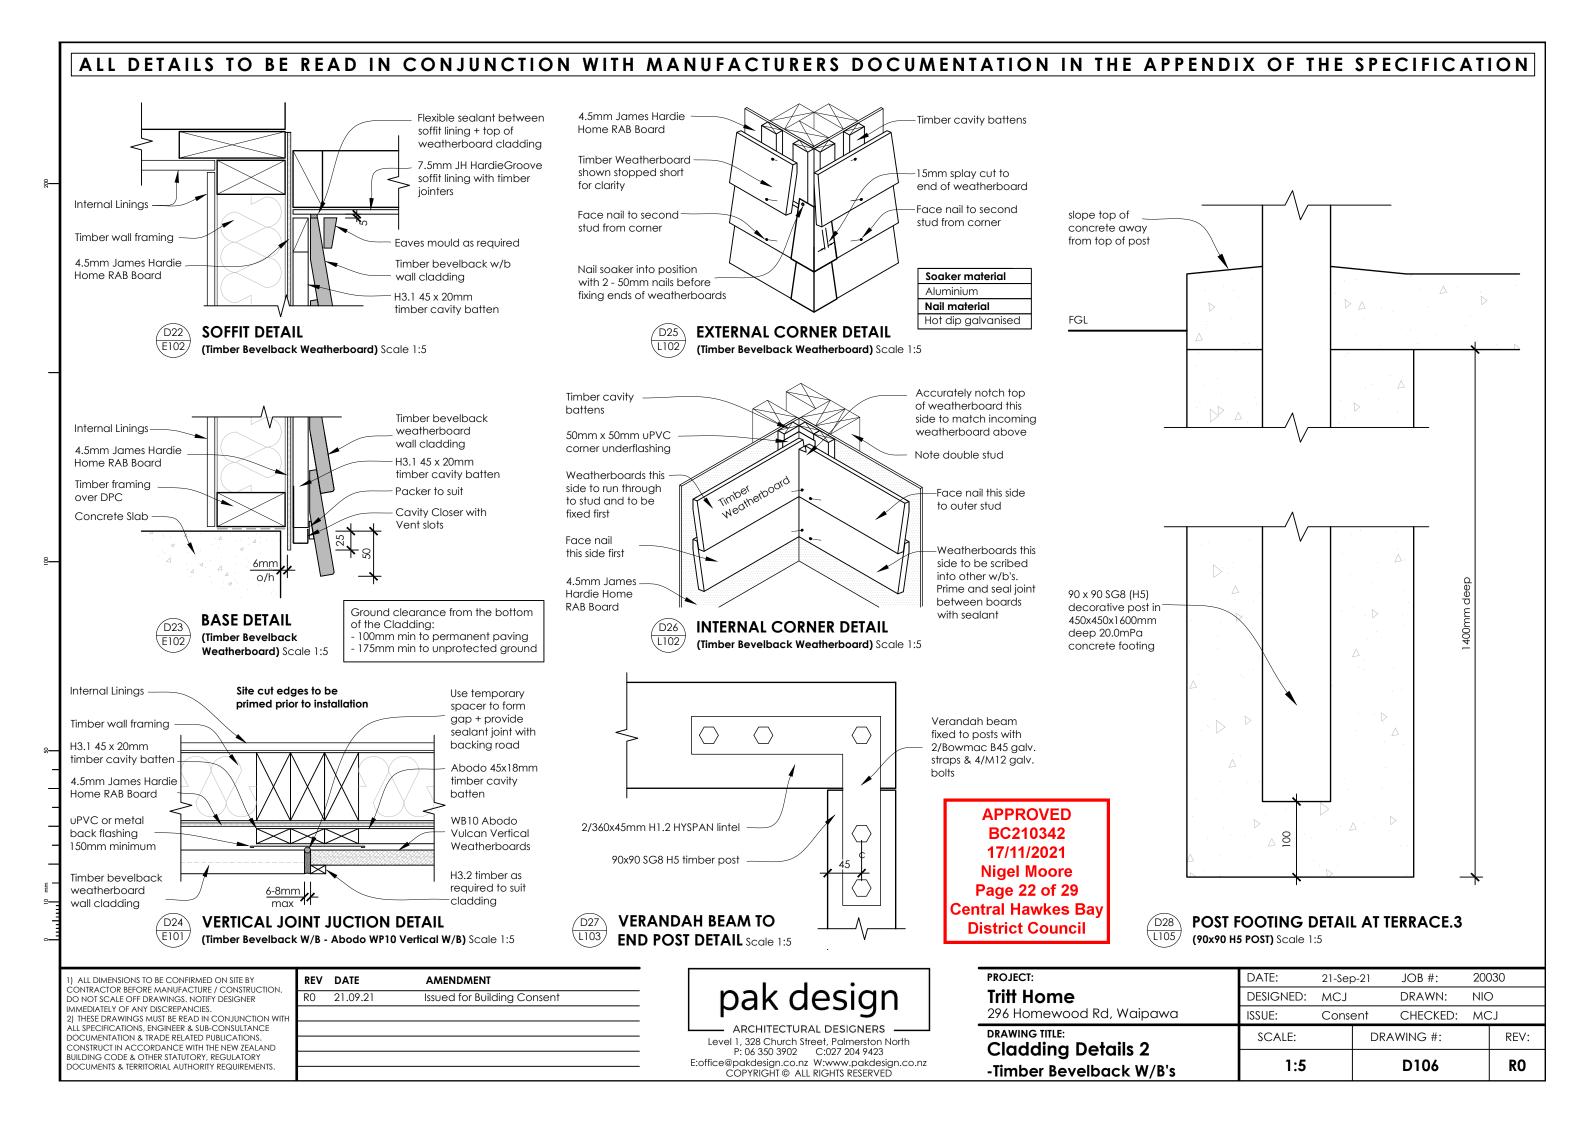

#### ALL DETAILS TO BE READ IN CONJUNCTION WITH MANUFACTURERS DOCUMENTATION IN THE APPENDIX OF THE SPECIFICATION DPC under timber framed wall DPC under timber framed wall Selected Cladding Selected Cladding 300mm lap 300mm lap fixed over drained fixed over drained cavity cavity 500E 665 mesh 500E 665 mesh 100mm topping 100mm topping slab 20.0 MPa slab 20.0 MPa Thermathene concrete Thermathene concrete FPL underlay to terminate underlay to terminate at starter bar at starter bar Expol Thermaslab **Expol Thermaslab** 50mm Underfloor 50mm Underfloor **FGL** FGL Insulation Insulation 25mm min sand 25mm min sand **Plaster** Plaster blinding layer blinding layer foundation foundation edge D12 bar to top /edge D12 bar to top of footing + to of footing + to 75 75 edge of slab edge of slab 150mm min general all 150mm min general all purpose well graded hardfill, purpose well graded hardfill, max 40mm granular size max 40mm granular size R10 stirrups @ 600crs R10 stirrups @ 600crs 2/D12 bars 2/D12 bars 200 200 **SLAB EDGE FOOTING DETAIL SLAB EDGE FOOTING DETAIL** \L105 (Hard as Rocks Eldorado Stone Veneer) Scale 1:5 (Timber Bevelback Weatherboard) Scale 1:5 **APPROVED NOTES:** Where Good Ground is located at a depth BC210342 Good ground definition see NZS 3604 exceeding 600mm, the extra depth required 2011 3.4.1 & depth see 3.4.2 below 3604 standard details may be filled with mass 17/11/2021 Min external cover to reinforcing: concrete, having a strength of 10MPa at 28 days or **Nigel Moore** Against ground 75mm refer to engineers details for foundation edge Against form work 50mm Page 23 of 29 These details are for well drained soils. For poorly Top cover to mesh 30mm drained soils refer to NZBC E2/AS1 **Central Hawkes Bay District Council** PROJECT: DATE: JOB #: 20030 12-Nov-21 ALL DIMENSIONS TO BE CONFIRMED ON SITE BY CONTRACTOR BEFORE MANUFACTURE / CONSTRUCTION **REV DATE AMENDMENT** pak design **Tritt Home** DESIGNED: MCJ DRAWN: NIO RO 21.09.21 Issued for Building Consent DO NOT SCALE OFF DRAWINGS. NOTIFY DESIGNER IMMEDIATELY OF ANY DISCREPANCIES R1 12.11.21 Details D29 + D30 revised 296 Homewood Rd, Waipawa ISSUE: Consent CHECKED: MCJ 2) THESE DRAWINGS MUST BE READ IN CONJUNCTION WI ALL SPECIFICATIONS, ENGINEER & SUB-CONSULTANCE DOCUMENTATION & TRADE RELATED PUBLICATIONS. DRAWING TITLE: SCALE: DRAWING #: REV: Level 1, 328 Church Street, Palmerston North CONSTRUCT IN ACCORDANCE WITH THE NEW ZEALAND BUILDING CODE & OTHER STATUTORY, REGULATORY **Foundation Details** E:office@pakdesign.co.nz W:www.pakdesign.co.nz 1:5 D107 R1 DOCUMENTS & TERRITORIAL AUTHORITY REQUIREMENTS. COPYRIGHT © ALL RIGHTS RESERVED

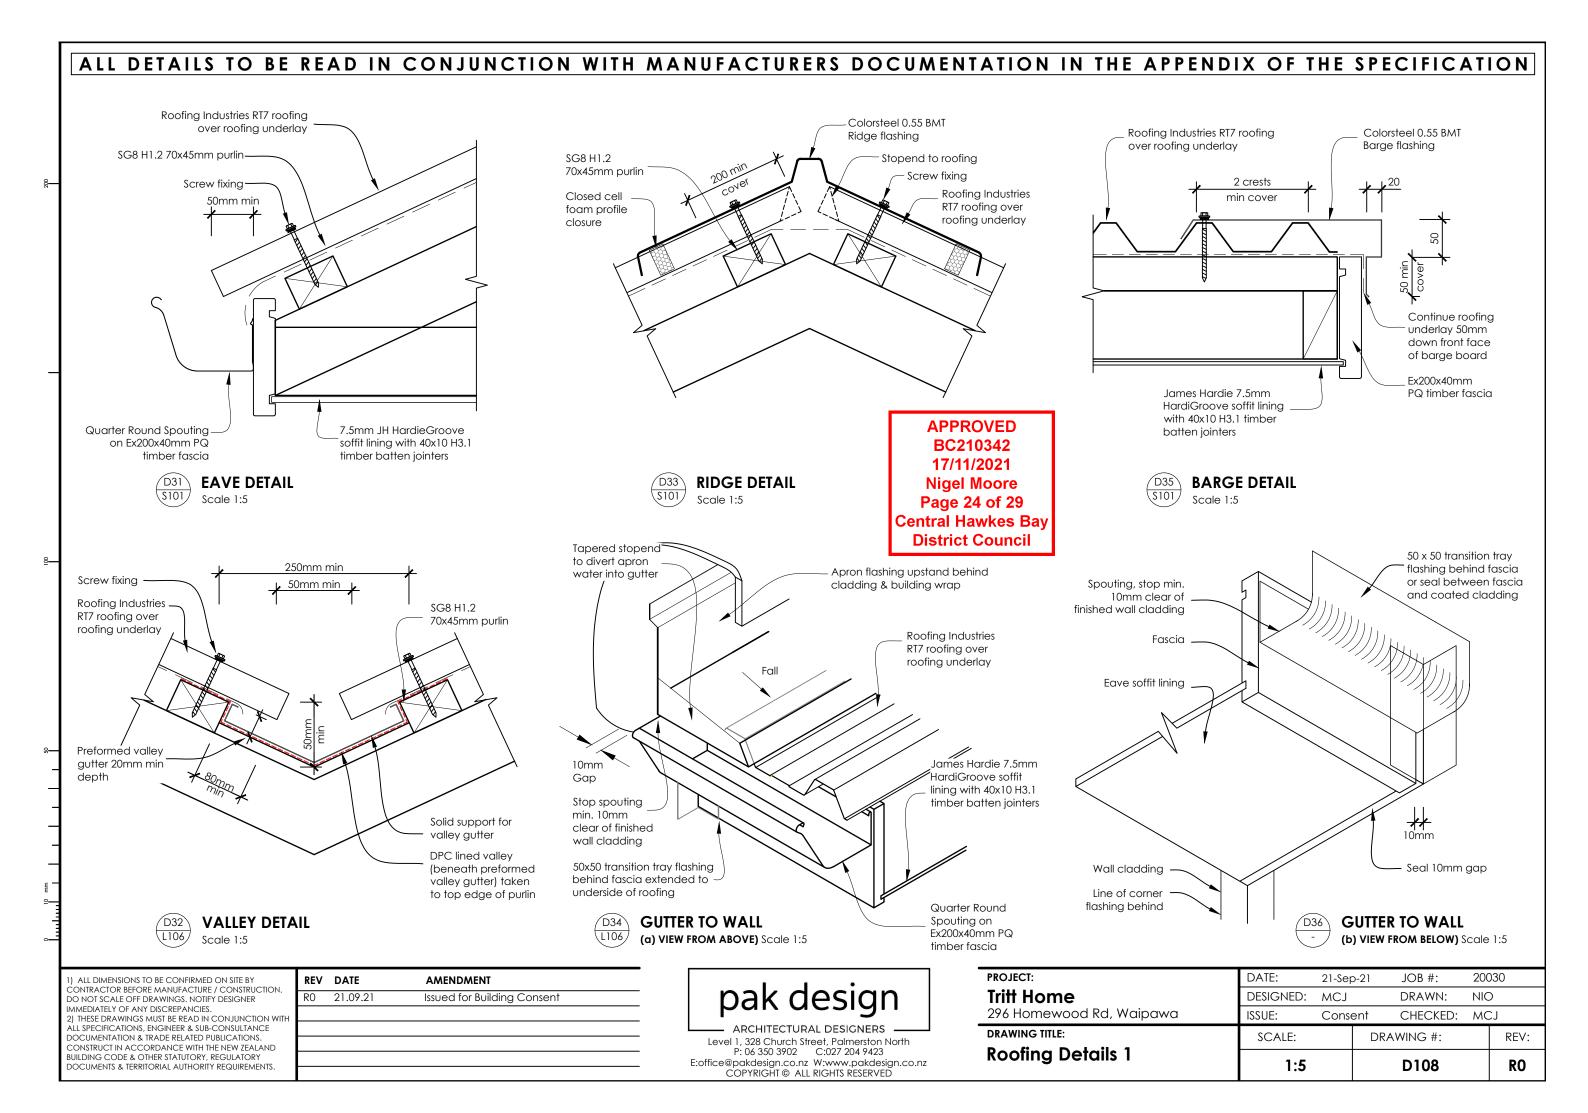

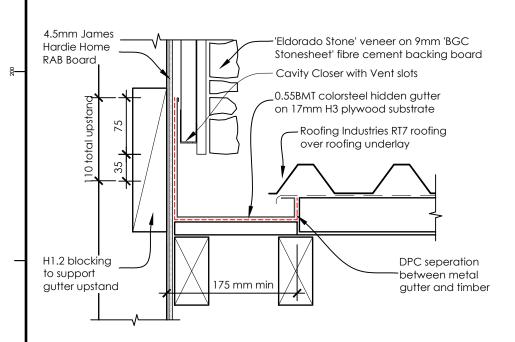




#### HIDDEN GUTTER TO WALL DETAIL


- SIDE OF CHIMNEY Scale 1:5

#### **Installation Instructions:** DEKTITE PREMIUM DFE103B

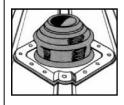

For more effective drainage, always fit the Dektite on the diamond or bias. Dektites are suitable r flashing pipes that

penetrate wall claddings

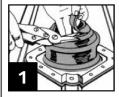


Cut a neat hole in roofing sheet with minimum clearance for pipe and insert pipe through hole. Trim the cone to suit pipe size usina sharp tin snips Where required, support cut sections of sheet with

Slide Dektite flashing down over pipe. Lubricating the



L106

pipe with water allows the pipe to slide snuggly into

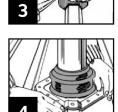



Fasten using self drilling washered screws or sealed progressively outward in opposing pairs to

Apply a neutral-cure silicone

sealant by turning back the flexible flange. The following

silicones have been trialled

and provided a suitable bond:

• OCI Roof & Gutter N-192

OCI ROOT & GUTTER N-192
Selleys roof & Gutter
Bostik Findley Roof & Gutter
Dow Corning 791
Sikasil AP Multi Purpose

Press base to the roof

profile by hand, smooth


creases. Don't fully

extend to allow for


vibration.


### TERMINAL VENT PENETRATION DETAIL


Scale 1:5

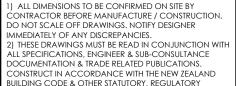



DOCUMENTS & TERRITORIAL AUTHORITY REQUIREMENTS.

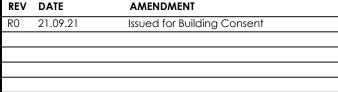


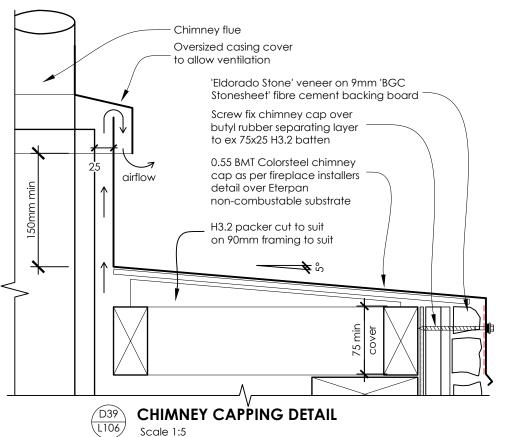

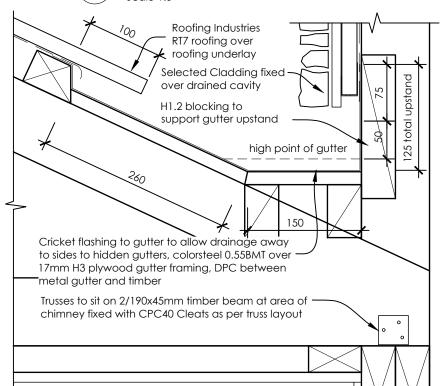

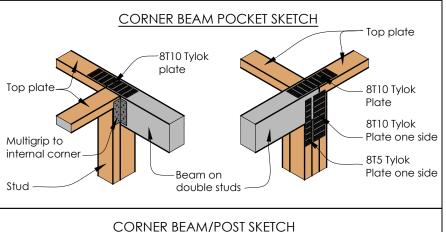

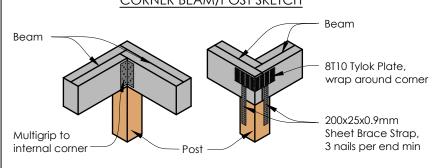

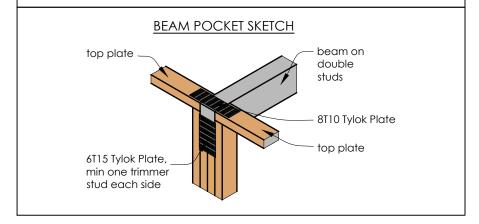


**APPROVED** BC210342 17/11/2021 **Nigel Moore** Page 25 of 29 **Central Hawkes Bay District Council** 


D40 **ROOF TO CHIMNEY DETAIL** \$101 Scale 1:5


## pak design

Level 1, 328 Church Street, Palmerston North E:office@pakdesign.co.nz W:www.pakdesign.co.nz COPYRIGHT © ALL RIGHTS RESERVED

PROJECT:	DATE:	21-Sep	o-21	JOB #:	200	030
Tritt Home	DESIGNED:	MCJ		DRAWN:	NIC	)
296 Homewood Rd, Waipawa	ISSUE:	Cons	ent	CHECKED:	MC	) J
DRAWING TITLE:	SCALE:		DRA	WING #:		REV:
Roofing Details 2	1:5			D109		RO

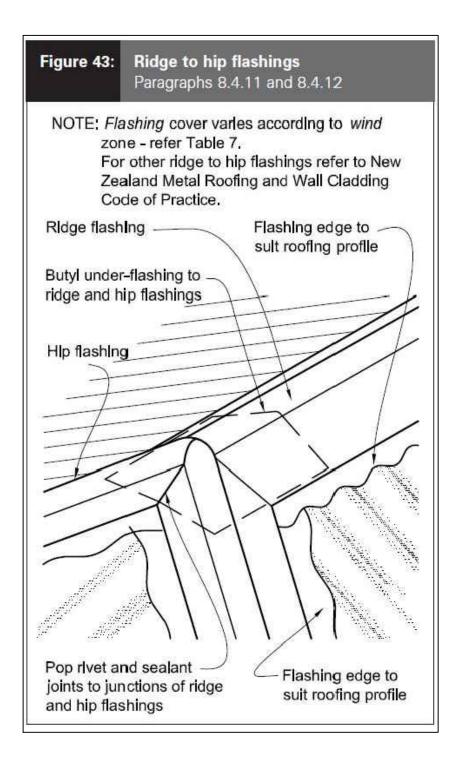


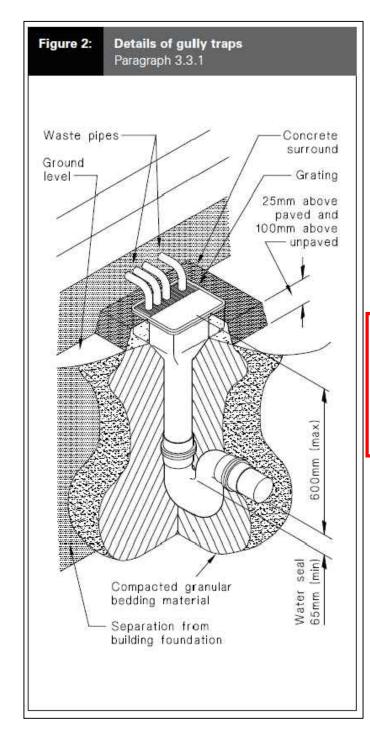

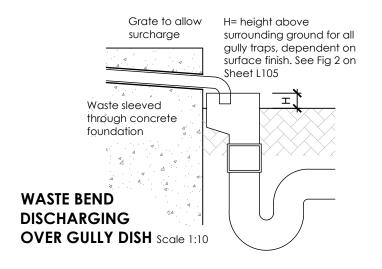

APPROVED
BC210342
17/11/2021
Nigel Moore
Page 26 of 29
Central Hawkes Bay
District Council

max. 9m plus three bends reduced to 100 mm where freezing likely, in which case <u>gra</u>ded pipe must be insulated (NZBC G12/AS1) (Refer to AS/NZS 3500.4 Table 5.4 air gap 25mm; if discharge is longer than 12m a 25mm relief valve air gap located in same place as storage heater - continuous fall must be incorporated to outlet (NZBC G12/AS1) - no valves on line final discharge must - max. 3 90° bends be in safe location where easily visible

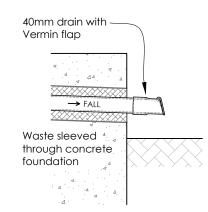

40mm DRAIN VERMIN FLAP SKETCH Scale 1:10

#### D41 L106

#### HIP TO RIDGE FLASHING DETAIL

Scale 1:5

DO NOT SCALE OFF DRAWINGS. NOTIFY DESIGNER

ALL DIMENSIONS TO BE CONFIRMED ON SITE BY
CONTRACTOR BEFORE MANUFACTURE / CONSTRUCTION

2) THESE DRAWINGS MUST BE READ IN CONJUNCTION WI ALL SPECIFICATIONS, ENGINEER & SUB-CONSULTANCE DOCUMENTATION & TRADE RELATED PUBLICATIONS.

CONSTRUCT IN ACCORDANCE WITH THE NEW ZEALAND BUILDING CODE & OTHER STATUTORY, REGULATORY

DOCUMENTS & TERRITORIAL AUTHORITY REQUIREMENTS.


REV DATE AMENDMENT

R0 12.11.21 Issued for Building Consent

### GULLY TRAP DETAIL Scale 1:5

pak c	lesign
ADCLUTECTU	AL DESIGNEDS

PROJECT:	DATE:	12-No	v-21 JOB #:	200	20030	
Tritt Home	DESIGNED:	MCJ	DRAWN:	NIC	NIO	
296 Homewood Rd, Waipawa	ISSUE:	Conse	ent CHECKED	CHECKED: MC		
DRAWING TITLE:	SCALE:		DRAWING #:		REV:	
Various Details 1	1:5, 1:10		D110		RO	

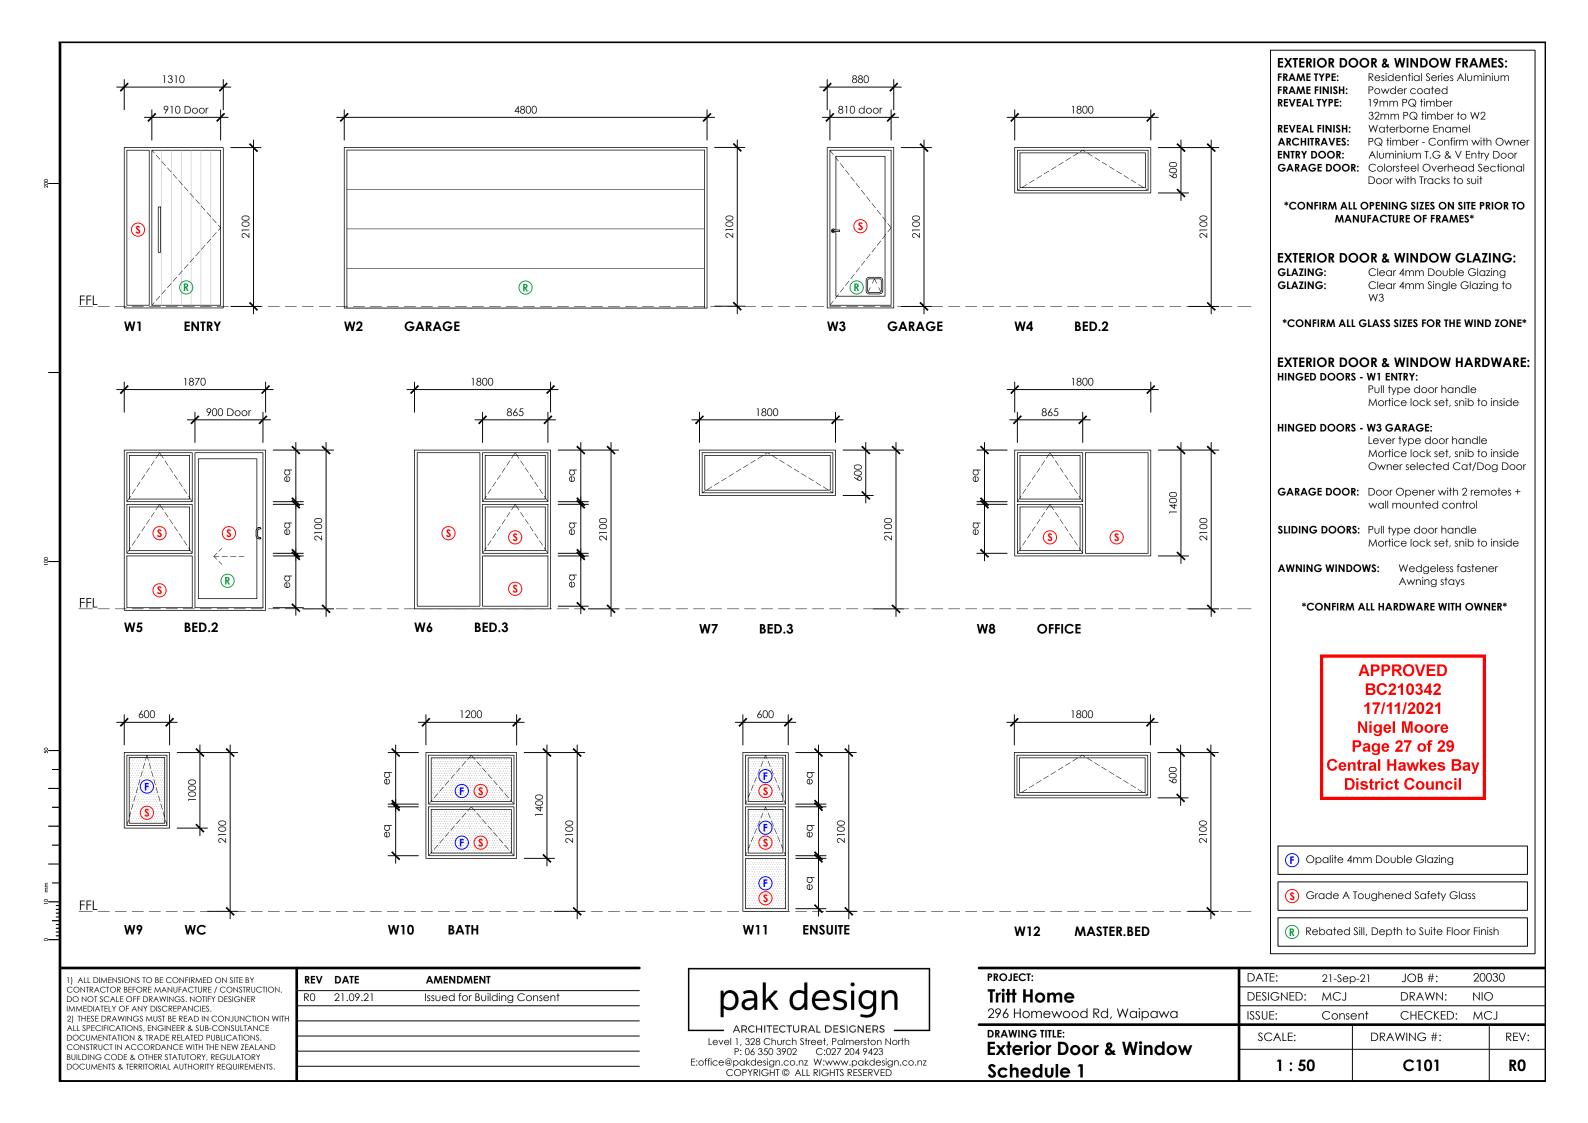



ON NOT SCALE OFF DRAWINGS, NOTIFY DESIGNER
IMMEDIATELY OF ANY DISCREPANCIES.

2) THESE DRAWINGS MUST BE READ IN CONJUNCTION WITH
ALL SPECIFICATIONS, ENGINEER & SUB-CONSULTANCE
DOCUMENTATION & TRADE RELATED PUBLICATIONS.
CONSTRUCT IN ACCORDANCE WITH THE NEW ZEALAND
BUILDING CODE & OTHER STATUTORY, REGULATORY
DOCUMENTS & TERRITORIAL AUTHORITY REQUIREMENTS.

R0 21.09.21 Issued for Building Consent

pak design

DATE:	21-Sep-21 ED: MCJ		JOB #:	200	030
DESIGNED:			DRAWN:	NIO	
ISSUE:	Conse	ent	CHECKED:	MCJ	
SCALE:		DRAWING #:			REV:
1 : 50		C102			RO
	DESIGNED: ISSUE: SCALE:	DESIGNED: MCJ ISSUE: Conse SCALE:	DESIGNED: MCJ ISSUE: Consent SCALE: DRA	DESIGNED: MCJ DRAWN:  ISSUE: Consent CHECKED:  SCALE: DRAWING #:	DESIGNED: MCJ DRAWN: NIC ISSUE: Consent CHECKED: MC SCALE: DRAWING #:

